

Meriden-Markham Municipal Airport City of Meriden, Connecticut


Contract Plans For:

# CONSTRUCT 4-UNIT HANGAR








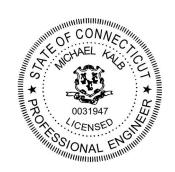

City of Meriden Contract No. B024-50 FAA AIP No. 3-09-0012-xxx-2024 FAA BIL/AIG No. 3-09-0012-xxx-2024 Stantec Project No. 179450845 APRIL 4, 2024

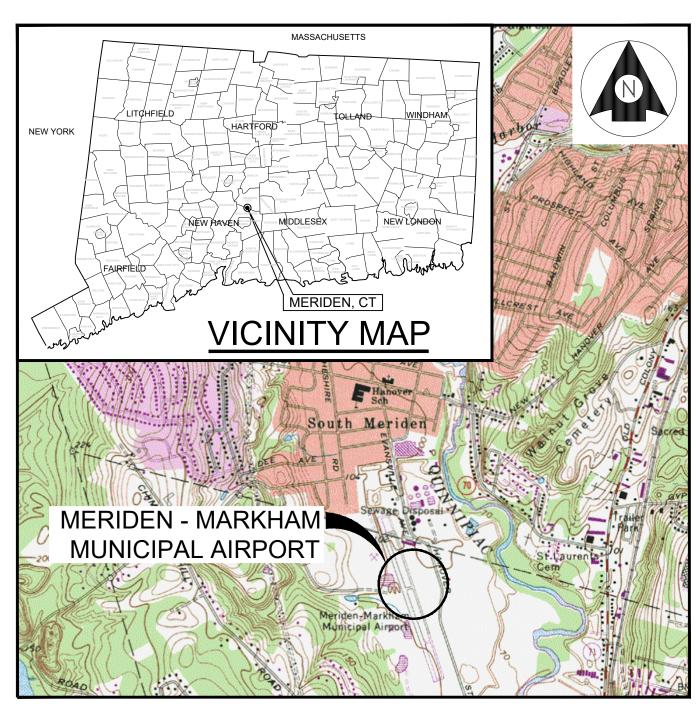

PROJECT LOCATION MAP

NOT TO SCALE

## INDEX OF DRAWINGS

INDEX OF DRA	AVVINGS
DRAWING NO.	TITLE
G.000	TITLE SHEET
C.001	GENERAL NOTES
C.002	CONSTRUCTION SAFETY AND PHASING PLAN
C.100	EXISTING CONDITIONS PLAN
C.101	LAYOUT PLAN
C.102	TYPICAL SECTION AND DETAILS
A.101	FLOOR PLAN ELEVATIONS
S.101	FOUNDATION PLAN
S.201	FOUNDATION SECTIONS
E.001	ELECTRICAL LEGEND AND GENERAL NOTES
E.101	ELECTRICAL SITE PLAN
E.201	HANGAR POWER AND LIGHTING PLAN
E.501	ELECTRICAL ONE-LINE AND DETAILS
E.601	ELECTRICAL SCHEDULES

- 3. MERIDEN-MARKHAM MUNICIPAL AIRPORT WILL BE IN OPERATION DURING THE CONSTRUCTION OF THIS PROJECT. ADVANCED COORDINATION OF ALL WORK WITH THE AIRPORT MANAGER AND THE RPR IS MANDATORY SO AS TO MINIMIZE IMPACTS ON AIRPORT OPERATIONS.
- 4. CONTRACTOR'S STAGING AREA AN AREA WILL BE MADE AVAILABLE FOR CONTRACTOR'S MOBILIZATION AND STORAGE. THE CONTRACTOR'S STAGING AREA SHALL BE RESTORED TO ITS PRE—CONSTRUCTION CONDITION UPON COMPLETION OF USE, AT THE CONTRACTOR'S EXPENSE.
- 5. EXISTING AIRFIELD LIGHTING SYSTEMS INTERRUPTION OF EXISTING AIRFIELD LIGHTING SYSTEMS NOT INCLUDED IN THIS PROJECT SHALL NOT BE PERMITTED. ALL AIRFIELD LIGHTING CIRCUITS AFFECTED BY THIS PROJECT SHALL BE MAINTAINED BY THE CONTRACTOR DURING OPERATIONAL PERIODS IN ACCORDANCE WITH THE SPECIFICATIONS AND/OR AS DIRECTED BY THE RPR.
- 6. ALL MATERIALS AND EQUIPMENT WHEN NOT IN USE SHALL BE PLACED IN APPROVED AREAS WHERE THEY WILL NOT CONSTITUTE A HAZARD TO AIRCRAFT OPERATIONS AND NOT PENETRATE CLEARANCE SURFACES. ALL EQUIPMENT SHALL BE PARKED AT THE STAGING AREA WHEN NOT IN USE.
- 7. FOR EMERGENCIES INVOLVING SAFETY (INJURIES, FIRES, SECURITY BREACHES, ETC.) THE CONTRACTOR SHALL MAKE DIRECT CONTACT WITH THE AIRPORT MANAGER (203) 630–2878 FOLLOWED BY NOTIFICATION TO THE RPR AS SOON AS POSSIBLE.
- B. THE CONTRACTOR SHALL PROVIDE THE PHONE NUMBERS OF THREE PERSONNEL, INCLUDING THE PROJECT SUPERINTENDENT WHO MAY BE CONTACTED IN AN EMERGENCY. PERSONNEL SHALL BE ON—CALL 24 HOURS PER DAY FOR MAINTAINING AIRPORT HAZARD LIGHTING AND BARRICADES.
- 9. IN ACCORDANCE WITH THE SPECIFICATIONS, LABOR WAGE RATES SHALL BE POSTED ON SITE IN A WEATHERPROOF ENCLOSURE.

# **CONSTRUCTION SAFETY NOTES**

- 1. ALL CONSTRUCTION FOR THIS PROJECT SHALL CONFORM TO THE GUIDELINES SET FORTH IN FEDERAL AVIATION ADMINISTRATION (FAA) AC150/5370-2G "OPERATIONAL SAFETY ON AIRPORTS DURING CONSTRUCTION", AND THESE PLANS AND SPECIFICATIONS.
- 2. THE CONTRACTOR SHALL FURNISH A SPCD (SAFETY PLAN COMPLIANCE DOCUMENT) WITHIN FIVE (5) DAYS PRIOR TO THE ISSUANCE OF A NOTICE TO PROCEED. THE CONTRACTOR SHALL BECOME KNOWLEDGEABLE OF THE REQUIREMENTS AND PROCEDURES OF FAA ADVISORY CIRCULAR 150/5370-2G AND THE CSPP, AND INCORPORATE THESE ITEMS IN TO THE SPCD.
- 3. THE CONTRACTOR SHALL ACQUAINT ITS SUPERVISORS AND EMPLOYEES WITH THE AIRPORT ACTIVITIES AND OPERATIONS THAT ARE INHERENT AT THIS AIRPORT AND SHALL CONDUCT ITS CONSTRUCTION ACTIVITIES TO CONFORM TO ALL ROUTINE AND EMERGENCY AIR TRAFFIC REQUIREMENTS AND TO THE GUIDELINES ON SAFETY.
- 4. CONSTRUCTION ACTIVITIES ARE NOT PERMITTED WITHIN THE SAFETY AREA/OBJECT FREE AREA OF AN ACTIVE RUNWAY. TAXIWAY OR APRON TAXILANE WITHOUT THE APPROVAL OF THE AIRPORT MANAGER.
- 5. IN ORDER FOR THE CONTRACTOR TO OPERATE WITHIN THE AIR OPERATIONS AREA (AOA), APPROPRIATE NOTICES TO AIRMEN (NOTAMS) MUST BE ISSUED BY THE AIRPORT MANAGER THROUGH THE FAA FLIGHT SERVICE STATION. THESE NOTICES PROVIDE INFORMATION ON CLOSED, LIMITED, OR HAZARDOUS CONDITIONS TO AIRMEN AND USERS OF THE AIRPORT. A 48-HOUR NOTICE IS REQUIRED FOR ISSUANCE OF THE NOTAM. ALL CONSTRUCTION OPERATIONS MUST BE CLOSELY COORDINATED WITH THE AIRPORT MANAGER FOR NOTAM ISSUANCE. ONCE ALL NOTAMS ARE IN PLACE THE CONTRACTOR SHALL SET UP CONSTRUCTION SAFETY DEVICES INCLUDING BUT NOT LIMITED TO, CONSTRUCTION SIGNS AND BARRICADES.
- 6. ALL CONTRACTOR VEHICLES, INCLUDING HAULING VEHICLES, THAT ARE AUTHORIZED TO OPERATE WITHIN THE SECURITY FENCE ON THE AIRPORT WITHIN THE DESIGNATED LIMITS OF CONSTRUCTION AS DEFINED HEREIN, SHALL DISPLAY IN FULL VIEW ABOVE THE VEHICLE A 3' x 3' OR LARGER ORANGE AND WHITE CHECKERBOARD FLAG, EACH CHECKERBOARD COLOR BEING 1' SQUARE. WHEN OPERATING DURING PERIODS OF DARKNESS OR LIMITED VISIBILITY, CONTRACTOR'S VEHICLES SHALL BE EQUIPPED WITH ROTATING OR FLASHING AMBER LIGHTS.
- 7. THE CONTRACTOR SHALL NOT PERMIT SMOKING OR OPEN FLAMES ON ANY PORTION OF THE AIRFIELD.
- 8. ONLY RUBBER-TIRED VEHICLES SHALL BE ALLOWED ON EXISTING PAVEMENT THAT IS TO REMAIN.
- 9. STOCKPILED MATERIAL SHALL BE CONSTRAINED IN A MANNER TO PREVENT MOVEMENT AS A RESULT OF AIRCRAFT OR WIND CONDITIONS IN EXCESS OF 10 KNOTS.
- 10. CONTRACTOR GENERATED DEBRIS, WASTE, AND LOOSE MATERIAL (INCLUDING DUST AND DIRT) CAPABLE OF CAUSING DAMAGE TO AIRCRAFT LANDING GEAR OR PROPELLERS, OR BEING INGESTED IN JET ENGINES, SHALL NOT BE ALLOWED ON ACTIVE AIRCRAFT MOVEMENT AREAS OR ADJACENT GRASSED AREAS. MATERIALS OBSERVED TO BE WITHIN THESE AREAS SHALL BE REMOVED IMMEDIATELY BY THE
- 11. CONTRACTOR ACCESS TO AIRFIELD PAVEMENTS OUTSIDE OF THE PROJECT WORK LIMITS IS STRICTLY
- 12. THE CONTRACTOR SHALL PROVIDE ADEQUATE SIGNING IN ACCORDANCE WITH MUTCD AND FLAGMAN AS REQUIRED FOR ALL OPERATIONS INCLUDING EQUIPMENT ENTERING & LEAVING ADJACENT ROADWAYS.
- 13. THE CONTRACTOR SHALL PROVIDE, INSTALL AND MAINTAIN FLASHING LIGHTS AND BARRICADES WHEREVER OPEN EXCAVATIONS OR IRREGULAR GRADES ARE LEFT WITHIN THE SAFETY AREA OF AN ACTIVE TAXIWAY OR WHERE TEMPORARY PAVEMENT CLOSURES OR AIRCRAFT LIMITATIONS ARE REQUIRED. BARRICADES SHALL BE SPACED NO MORE THAN 8 FEET ON CENTER OR AS NOTED ALONG THE AFFECTED PAVEMENT EDGE. THE CONTRACTOR SHALL DAILY MAINTAIN THE LIGHTS AND BARRICADES IN AN OPERABLE CONDITION FOR THE DURATION OF THE PROJECT.

- 14. THE CONTRACTOR SHALL PERFORM CONSTRUCTION OPERATIONS AS NECESSARY TO MINIMIZE ATTRACTION TO BIRDS CAUSED BY PONDED WATER AND GRASS SEED.
- 15. PROTECTION OF ALL PERSONS SHALL BE PROVIDED THROUGHOUT THE PROGRESS OF THE WORK. THE WORK SHALL PROCEED IN SUCH A MANNER AS TO PROVIDE SAFE CONDITIONS FOR ALL WORKERS INCLUDING AIRPORT PERSONNEL AND THE RPR. THE SEQUENCE OF OPERATIONS SHALL BE SUCH THAT MAXIMUM PROTECTION IS AFFORDED TO INSURE THAT PERSONNEL AND WORKERS IN THE WORK AREA ARE NOT SUBJECT TO ANY DANGEROUS CONDITIONS.
- 16. DURING PERFORMANCE OF THIS CONTRACT, THE AIRPORT RUNWAY, TAXIWAYS, FUELING AREAS, AND AIRCRAFT PARKING APRONS SHALL REMAIN IN USE BY AIRCRAFT TO THE MAXIMUM EXTENT POSSIBLE. ALL AIRCRAFT TRAFFIC ON THESE AREAS SHALL HAVE PRIORITY OVER CONTRACTOR'S TRAFFIC. THE AIRPORT MANAGER RESERVES THE RIGHT TO ORDER THE CONTRACTOR AT ANY TIME TO VACATE ANY AREA NECESSARY TO MAINTAIN SAFE AIRCRAFT OPERATIONS. USE OF AREAS NEAR THE CONTRACTOR'S WORK WILL BE CONTROLLED TO MINIMIZE DISTURBANCE TO THE CONTRACTOR'S OPERATION. THE CONTRACTOR SHALL NOT ALLOW EMPLOYEES, SUBCONTRACTORS, SUPPLIERS, OR ANY OTHER UNAUTHORIZED PERSON TO ENTER OR REMAIN IN ANY AIRPORT AREA WHICH WOULD BE HAZARDOUS TO PERSONS OR TO AIRCRAFT OPERATIONS.
- 17. THE FOLLOWING ARE CONSIDERED SAFETY CONCERNS AND/OR HAZARDS:
- A. TRENCHES, HOLES, OR EXCAVATION ON OR ADJACENT TO ANY OPEN RUNWAY OR IN RUNWAY OR TAXIWAY SAFETY AREAS.
- B. UNMARKED/UNLIGHTED HOLES OR EXCAVATION IN ANY APRON, OPEN TAXIWAY, OPEN TAXILANE, OR RELATED SAFETY AREA.
- C. MOUNDS OR PILES OF EARTH, CONSTRUCTION MATERIALS, TEMPORARY STRUCTURES, OR OTHER OBJECTS IN THE VICINITY OF ANY OPEN RUNWAY, TAXIWAY, TAXILANE, OR IN ANY RELATED SAFETY, APPROACH, OR DEPARTURE AREA.
- D. VEHICLES OR EQUIPMENT, WHETHER OPERATING OR IDLE, ON ANY OPEN RUNWAY, TAXIWAY, TAXILANE OR IN ANY RELATED SAFETY, APPROACH, OR DEPARTURE AREA.
- E. VEHICLES, EQUIPMENT, EXCAVATION, STOCKPILES, OR OTHER MATERIALS WHICH COULD INTERFERE WITH ELECTRONIC SIGNALS FROM RADIOS OR ELECTRONIC NAVIGATIONAL AIDS (NAVAIDS).
- F. PAVEMENT DROP-OFFS LIPS (EITHER PERMANENT OR TEMPORARY) WHICH COULD CAUSE DAMAGE TO AIRCRAFT IF CROSSED AT NORMAL OPERATING SPEEDS. THE NORMAL MAXIMUM DROP-OFF OR LIP IS 1-1/2 INCHES.
- G. UNMARKED UTILITY, NAVAID, WEATHER SERVICE, RUNWAY LIGHTING, OR OTHER POWER OR SIGNAL CABLES THAT COULD BE DAMAGED DURING CONSTRUCTION.
- H. OBJECTS, WHETHER OR NOT MARKED OR FLAGGED, OR ACTIVITIES ANYWHERE ON OR IN THE VICINITY OF THE AIRPORT WHICH COULD BE DISTRACTING, CONFUSING, OR ALARMING TO PILOTS DURING AIRCRAFT OPERATIONS.
- I. UNFLAGGED/UNLIGHTED LOW VISIBILITY ITEMS SUCH AS TALL CRANES, DRILLS, AND THE LIKE ANYWHERE IN THE VICINITY OF ACTIVE RUNWAY, OR IN ANY APPROACH OR DEPARTURE
- 18. THE CONTRACTOR SHALL CONDUCT ACTIVITIES SO AS NOT TO VIOLATE ANY SAFETY STANDARDS CONTAINED HEREIN. THE CONTRACTOR SHALL INSPECT ALL CONSTRUCTION AND STORAGE AREAS AS OFTEN AS NECESSARY AND PROMPTLY TAKE ALL STEPS NECESSARY TO PREVENT/REMEDY ANY UNSAFE OR POTENTIALLY UNSAFE CONDITIONS OR ACTIVITIES DISCOVERED.

#### UNDERGROUND UTILITY NOTES

- 1. THE LOCATIONS OF THE UNDERGROUND UTILITIES SHOWN ON THE PLANS ARE CONSIDERED TO BE ONLY ESTIMATED LOCATIONS. ALL UTILITY LOCATIONS SHALL BE FIELD VERIFIED BY THE CONTRACTOR PRIOR TO COMMENCING CONSTRUCTION.
- 2. PROTECTION OF EXISTING AIRPORT UNDERGROUND CABLES IS THE RESPONSIBILITY OF THE CONTRACTOR. THE LOCATION OF THESE UTILITIES MUST BE VERIFIED BY THE CONTRACTOR. REPAIR OF CABLES DAMAGED DUE TO CONTRACTOR'S OPERATIONS MUST BE STARTED IMMEDIATELY AND CONTINUED UNTIL COMPLETED. ALL SUCH REPAIRS SHALL BE IN ACCORDANCE WITH THE SPECIFICATIONS AND SHALL BE AT THE CONTRACTOR'S EXPENSE. WHEN FAA CABLES ARE DAMAGED, REPAIRS SHALL BE DONE IN ACCORDANCE WITH FAA REQUIREMENTS AND IN THE PRESENCE OF AN FAA REPRESENTATIVE. THE FAA MAY ELECT TO HAVE THE REPAIR PERFORMED BY OTHERS IN WHICH CASE THE CONTRACTOR SHALL BE RESPONSIBLE FOR PAYING THE INCURRED COST OF REPAIRS.
- 3. AT LEAST THREE (3) WORKING DAYS PRIOR TO COMMENCING CONSTRUCTION OPERATIONS IN AN AREA WHICH MAY INVOLVE UNDERGROUND UTILITY FACILITIES, THE CONTRACTOR SHALL NOTIFY THE RPR AND THE OWNER OF EACH UNDERGROUND UTILITY FACILITY AFFECTED.
- 4. AT LEAST TWO (2) FULL WORKING DAYS PRIOR TO COMMENCEMENT OF EXCAVATION, THE CONTRACTOR SHALL CONTACT "CALL BEFORE YOU DIG" AT 1-800-922-4455 FOR ASSISTANCE IN LOCATING UNDERGROUND UTILITIES.

## **SURVEY NOTES**

- 1. THIS SURVEY HAS BEEN PREPARED BY FREEMAN COMPANIES, LLC. IN ACCORDANCE WITH THE REGULATIONS OF CONNECTICUT STATE AGENCIES, SECTIONS 20—300b—1 THRU 20—300b—20 AND THE "STANDARDS FOR SURVEYS AND MAPS IN THE STATE OF CONNECTICUT" ADOPTED BY THE CONNECTICUT ASSOCIATION OF LAND SURVEYORS. INC. ON SEPTEMBER 26, 1996
- 1.1. THIS PLAN CONFORMS TO TOPOGRAPHIC ACCURACY CLASS T-2.
- 1.2. THE TYPE OF SURVEY PERFORMED IS A LIMITED TOPOGRAPHIC SURVEY AND IS INTENDED TO DEPICT EXISTING CONDITIONS WITHIN THE AREA SHOWN.
- 2. NORTH ARROW AND BEARINGS REFER TO THE CONNECTICUT STATE PLANE COORDINATE SYSTEM NAD83 AND IS BASED UPON GPS OBSERVATIONS PERFORMED BY FREEMAN COMPANIES, LLC.
- 3. ELEVATIONS REFER TO NAVD88 AND ARE BASED ON GPS OBSERVATIONS PERFORMED BY FREEMAN COMPANIES, LLC.
- 4. THE UNDERGROUND FEATURES DEPICTED HEREON ARE THE RESULT OF COMPILATION OF EXISTING MAPPING AND LOCATION OF VISIBLE EVIDENCE. OTHER UTILITIES MAY EXIST WHICH ARE NOT SHOWN. VERIFY INFORMATION IN THE FIELD BEFORE ANY DIGGING OR SITE EXCAVATION CALL, "CALL BEFORE YOU DIG" 1800—922—4455.



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Notes

Revision

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Client/Project Logo



Client/Project

Meridan-Markham Municipal Airport

CONSTRUCT 4 - UNIT HANGARS

Meriden, CT

Title

GENERAL NOTES

Project No.

179450845

Revision Sheet

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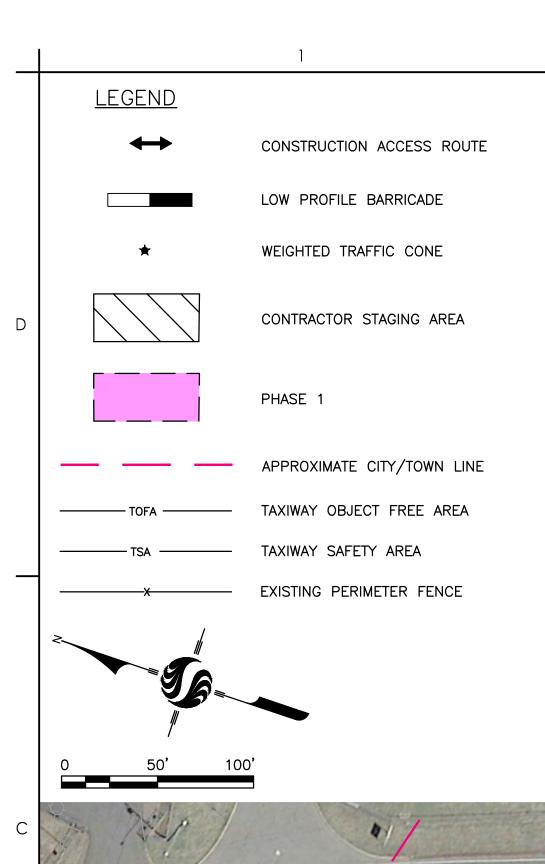
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Drawing No.

2 of 14

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# I. PHASE I:

PHASE I SHALL CONSIST OF MINOR GRADING AND DRAINAGE, INSTALLATION OF HANGAR FOUNDATIONS, ERECTION OF HANGAR, INSTALLATION OF HANGAR DOORS, ELECTRICAL HOOK UPS, PLACEMENT AND COMPACTION OF CRUSHED AGGREGATE BASE COURSE AND SITE RESTORATION/TURF ESTABLISHMENT.

ASPHALT PAVING OF HANGAR APRON TO BE COMPLETED BY OTHERS.

# II. CLOSURES:

• HANGAR TAXILANE EAST WILL REMAIN OPEN

# III. SCHEDULE:

- UPON THE ISSUANCE OF A NOTICE TO PROCEED, THE TOTAL CONSTRUCTION DURATION
- FOR PHASE I WILL BE 150 CALENDAR DAYS. • WORK SHALL BE PERFORMED DURING DAYTIME HOURS.


# IV. DESCRIPTION OF MAJOR WORK EFFORTS:

- FURNISH AND INSTALL EROSION AND SEDIMENT CONTROL DEVICES. • FURNISH AND INSTALL TRAFFIC CONTROL DEVICES (ie. WEIGHTED CHANNELIZER CONES, SIGNAGE, BARRICADES, ETC.).
- ESTABLISH CONTRACTOR STAGING/LAYDOWN AREA
- FURNISH AND INSTALL DRAINAGE PIPES AND STRUCTURES
- FURNISH AND INSTALL HANGAR FOUNDATION; FROST WALLS AND FLOOR SLAB
- FURNISH AND ERECT HANGAR STRUCTURE • FURNISH AND INSTALL HANGAR: ROOF, SIDING, HANGAR DOORS, ECT.
- FURNISH AND INSTALL ELECTRICAL
- FURNISH AND INSTALL CRUSHED AGGREGATE BASE COURSE FOR HANGAR APRON
- FURNISH AND PLACE OFF-SITE TOPSOIL AND HYDROSEED

#### CSPP NOTES:

1. SEE DRAWING C.001 FOR GENERAL NOTES.

- 2. THIS PLAN HAS BEEN APPROVED BY THE MERIDEN-MARKHAM MUNICIPAL AIRPORT (MMK). NO CHANGES OR MODIFICATIONS TO THIS PLAN WILL BE PERMITTED WITHOUT ADVANCED WRITTEN APPROVAL BY THE RPR.
- 3. SCHEDULING OF ALL WORK SHALL BE COORDINATED IN WRITING WITH THE AIRPORT MANAGER THOUGH THE RPR A MINIMUM OF 48 HOURS IN ADVANCE.
- 4. THERE IS NO SEPARATE PAY ITEM TO PROVIDE AND MAINTAIN TRAFFIC CONTROL DEVICES AND MEASURES INCLUDING BUT NOT LIMITED TO LIGHTED BARRICADES, WEIGHTED CONES, SIGNING, TEMPORARY STRIPING, ETC. ALL WORK ASSOCIATED WITH THESE MEASURES IS CONSIDERED INCIDENTAL TO THE PROJECT.
- 5. THE CONTRACTOR SHALL BE RESPONSIBLE FOR MODIFICATIONS AND RESTORATION OF THE EXISTING GATE AND FENCE LINE (IF NECESSARY) TO ALLOW CONSTRUCTION VEHICLE ACCESS TO THE WORK AREA AT NO ADDITIONAL EXPENSE TO THE OWNER.
- 6. THE CONTRACTOR SHALL CONTINUOUSLY COORDINATE WITH THE RPR AND THE AIRPORT MANAGER REGARDING DAILY CONSTRUCTION ACTIVITIES/OPERATIONS.
- 7. RESTORATION OF TURF AREAS AFFECTED BY CONSTRUCTION ACTIVITIES/STAGING IS CONSIDERED INCIDENTAL TO ALL OTHER PAY
- 8. THE CONTRACTOR SHALL PROTECT THE EXISTING HANGAR BUILDINGS DURING CONSTRUCTION. ANY DAMAGE CAUSED BY CONSTRUCTION OPERATIONS SHALL BE REPAIRED/REPLACED AT NO COST TO THE AIRPORT AND/OR TENANTS.
- 9. THE CONTRACTOR SHALL PROVIDE APPROPRIATE CONSTRUCTION ENTRANCE WARNING SIGNS ALONG EVANSVILLE AVE. AND HANOVER STREET DURING CONSTRUCTION, MEETING THE REQUIREMENTS OF USDOT FHA MANUAL OF UNIFORM TRAFFIC CONTROL DEVICES, LATEST EDITION. THE RPR SHALL APPROVE THE SIGNING PACKAGE PRIOR TO INSTALLATION. THIS WORK IS CONSIDERED INCIDENTAL TO THE PROJECT.

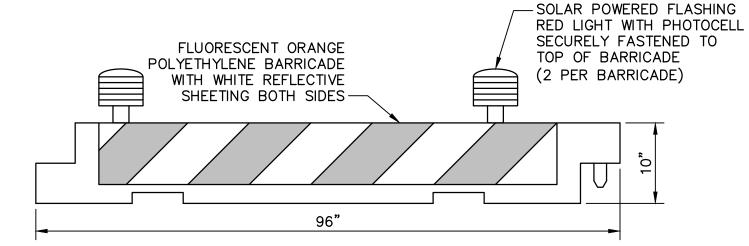

#### SAFETY BARRICADE NOTES:

- 1. THERE IS NO SEPARATE PAY ITEM FOR LIGHTED SAFETY BARRICADES AND THIS WORK IS CONSIDERED INCIDENTAL TO THE PROJECT.
- 2. THE LIGHTED SAFETY BARRICADES SHALL BE USED WHEN A WORK AREA IS DIRECTLY ADJACENT TO AN ACTIVE RUNWAY, TAXIWAY OR TAXILANE TO KEEP AIRCRAFT AND VEHICLES FROM TRAVELING INTO A WORK AREA.
- 3. BARRICADES SHALL BE INTERCONNECTED ON AIRFIELD PAVEMENTS OR AS IDENTIFIED ON PLANS.
- 4. THE CONTRACTOR SHALL BE RESPONSIBLE FOR RELOCATING AND/OR PROVIDING ADDITIONAL BARRICADES AROUND THE SITE AS NECESSARY TO ACCOMMODATE THE PROPOSED WORK.
- 5. THE CONTRACTOR SHALL ENSURE THE CONTINUOUS OPERATION OF ALL LIGHTS FOR THE DURATION OF THE PROJECT. LIGHTS AND/OR BATTERIES SHALL BE REPLACED AS NEEDED.
- 6. THE BARRICADES SHALL BE FILLED WITH WATER OR OTHERWISE SECURED TO PREVENT MOVEMENT.



INSTALL CONSTRUCTION

ENTRANCE WARNING SIGNS IN




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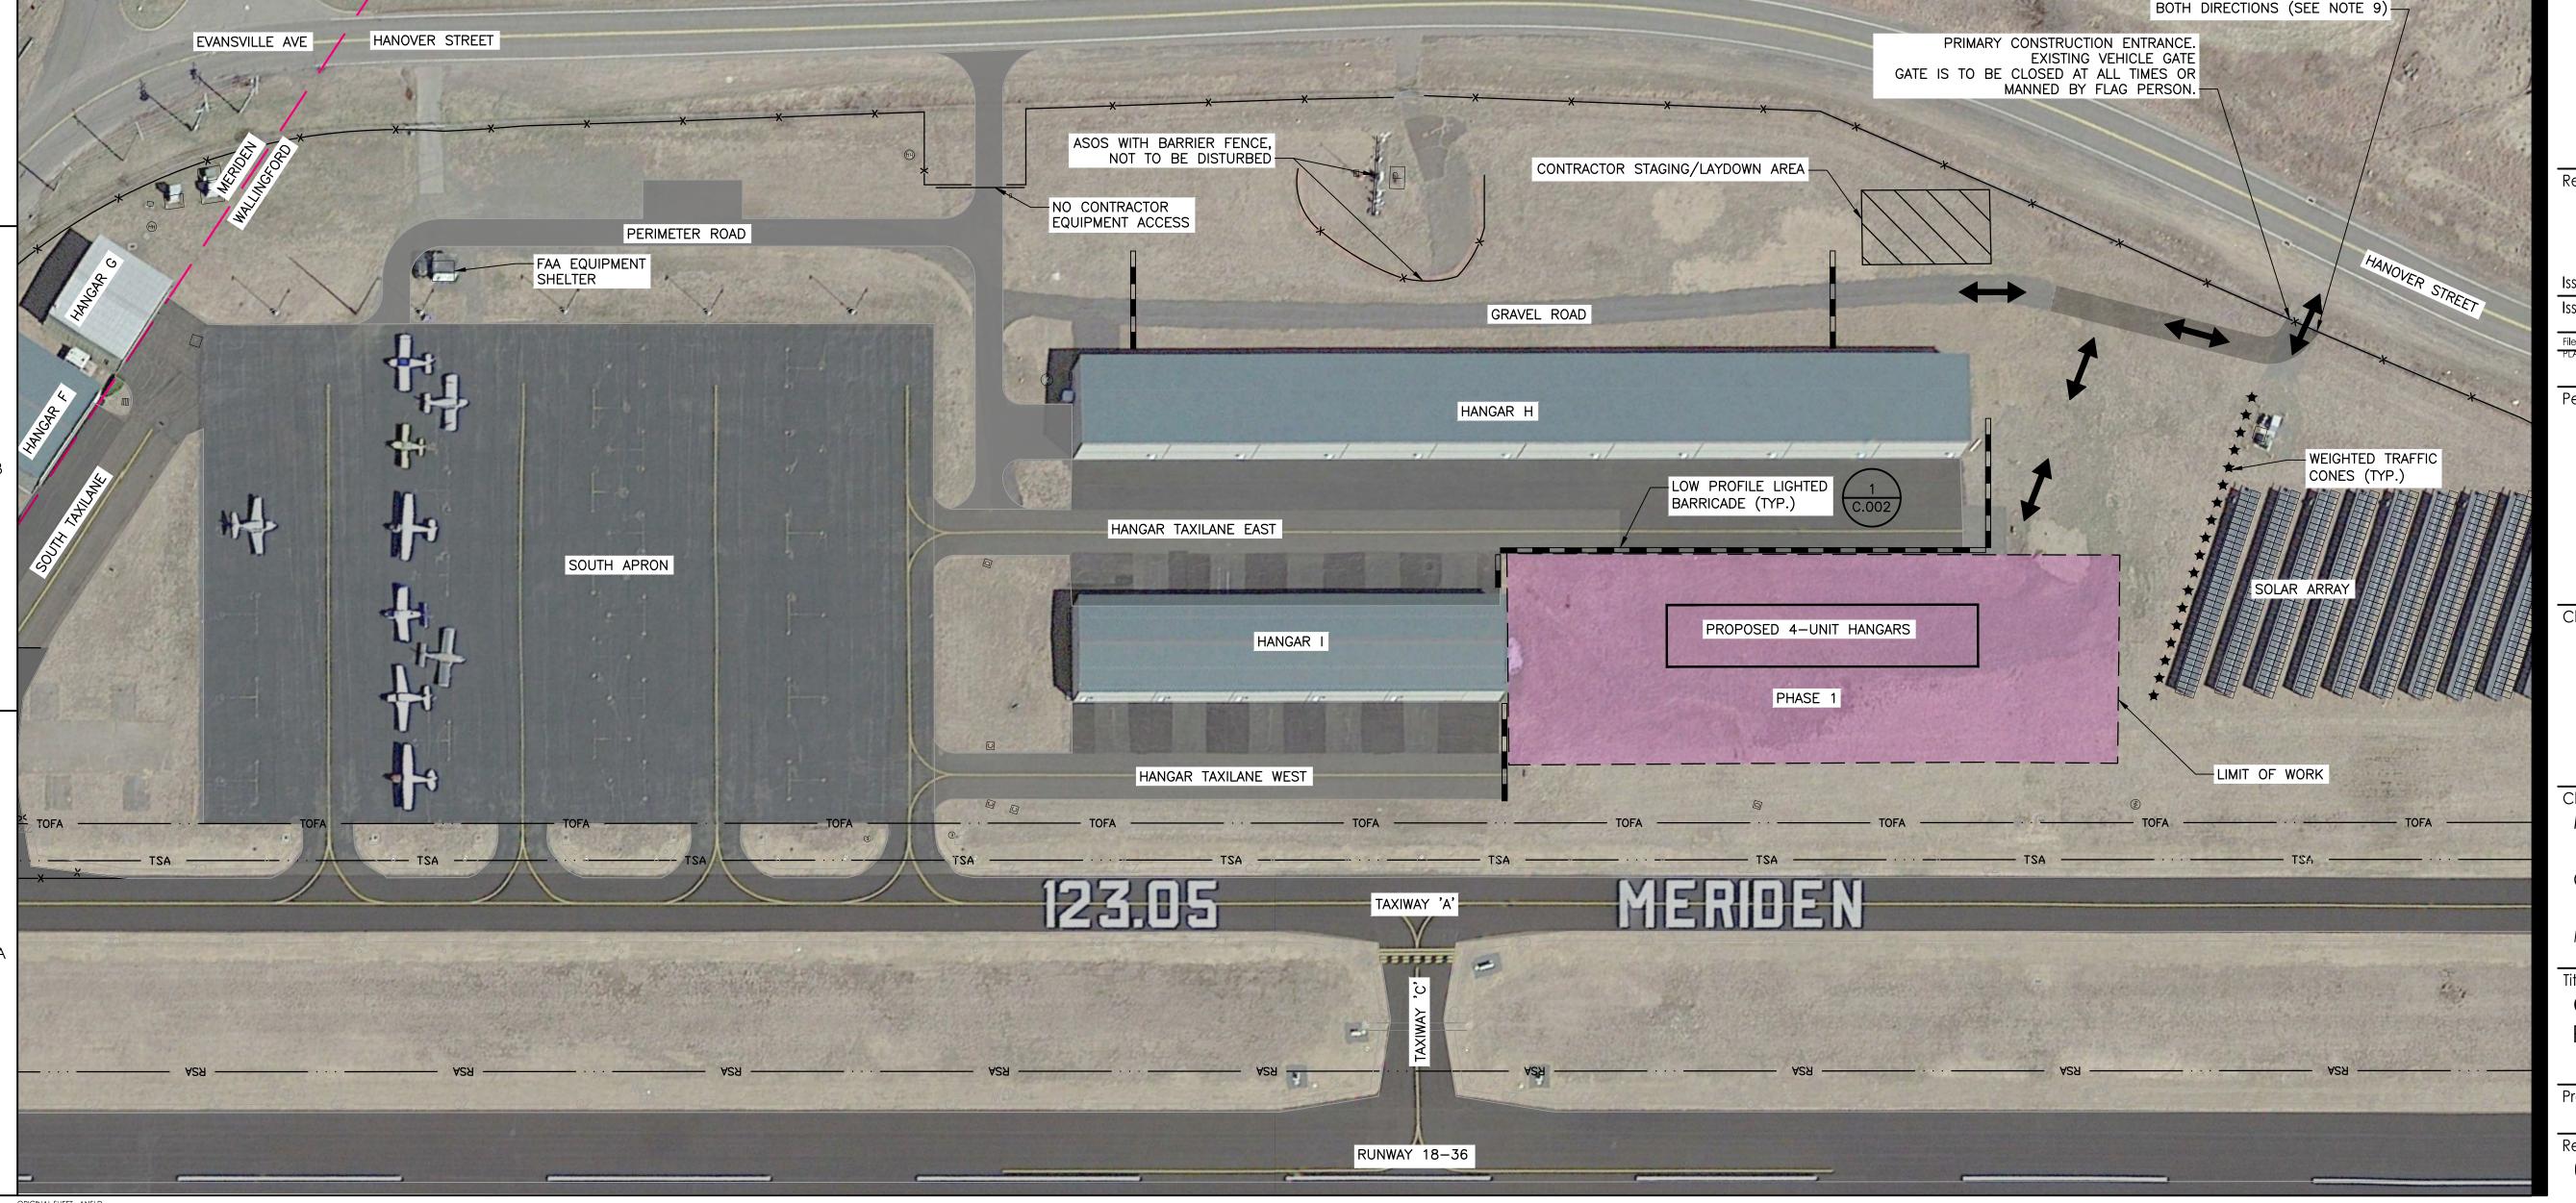
Meridan-Markham Municipal Airport


CONSTRUCT 4 - UNIT HANGARS


Meriden, CT

CONSTRUCTION SAFETY AND PHASING PLAN

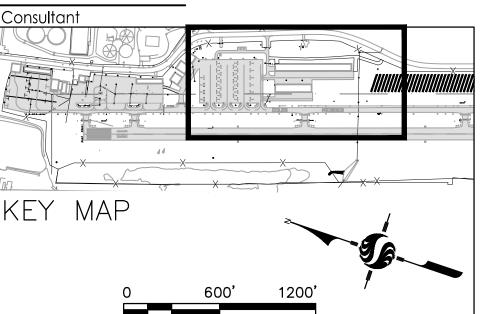Scale Project No. 179450845 AS SHOWN Revision Sheet Drawing No. 3 of 14 C-002




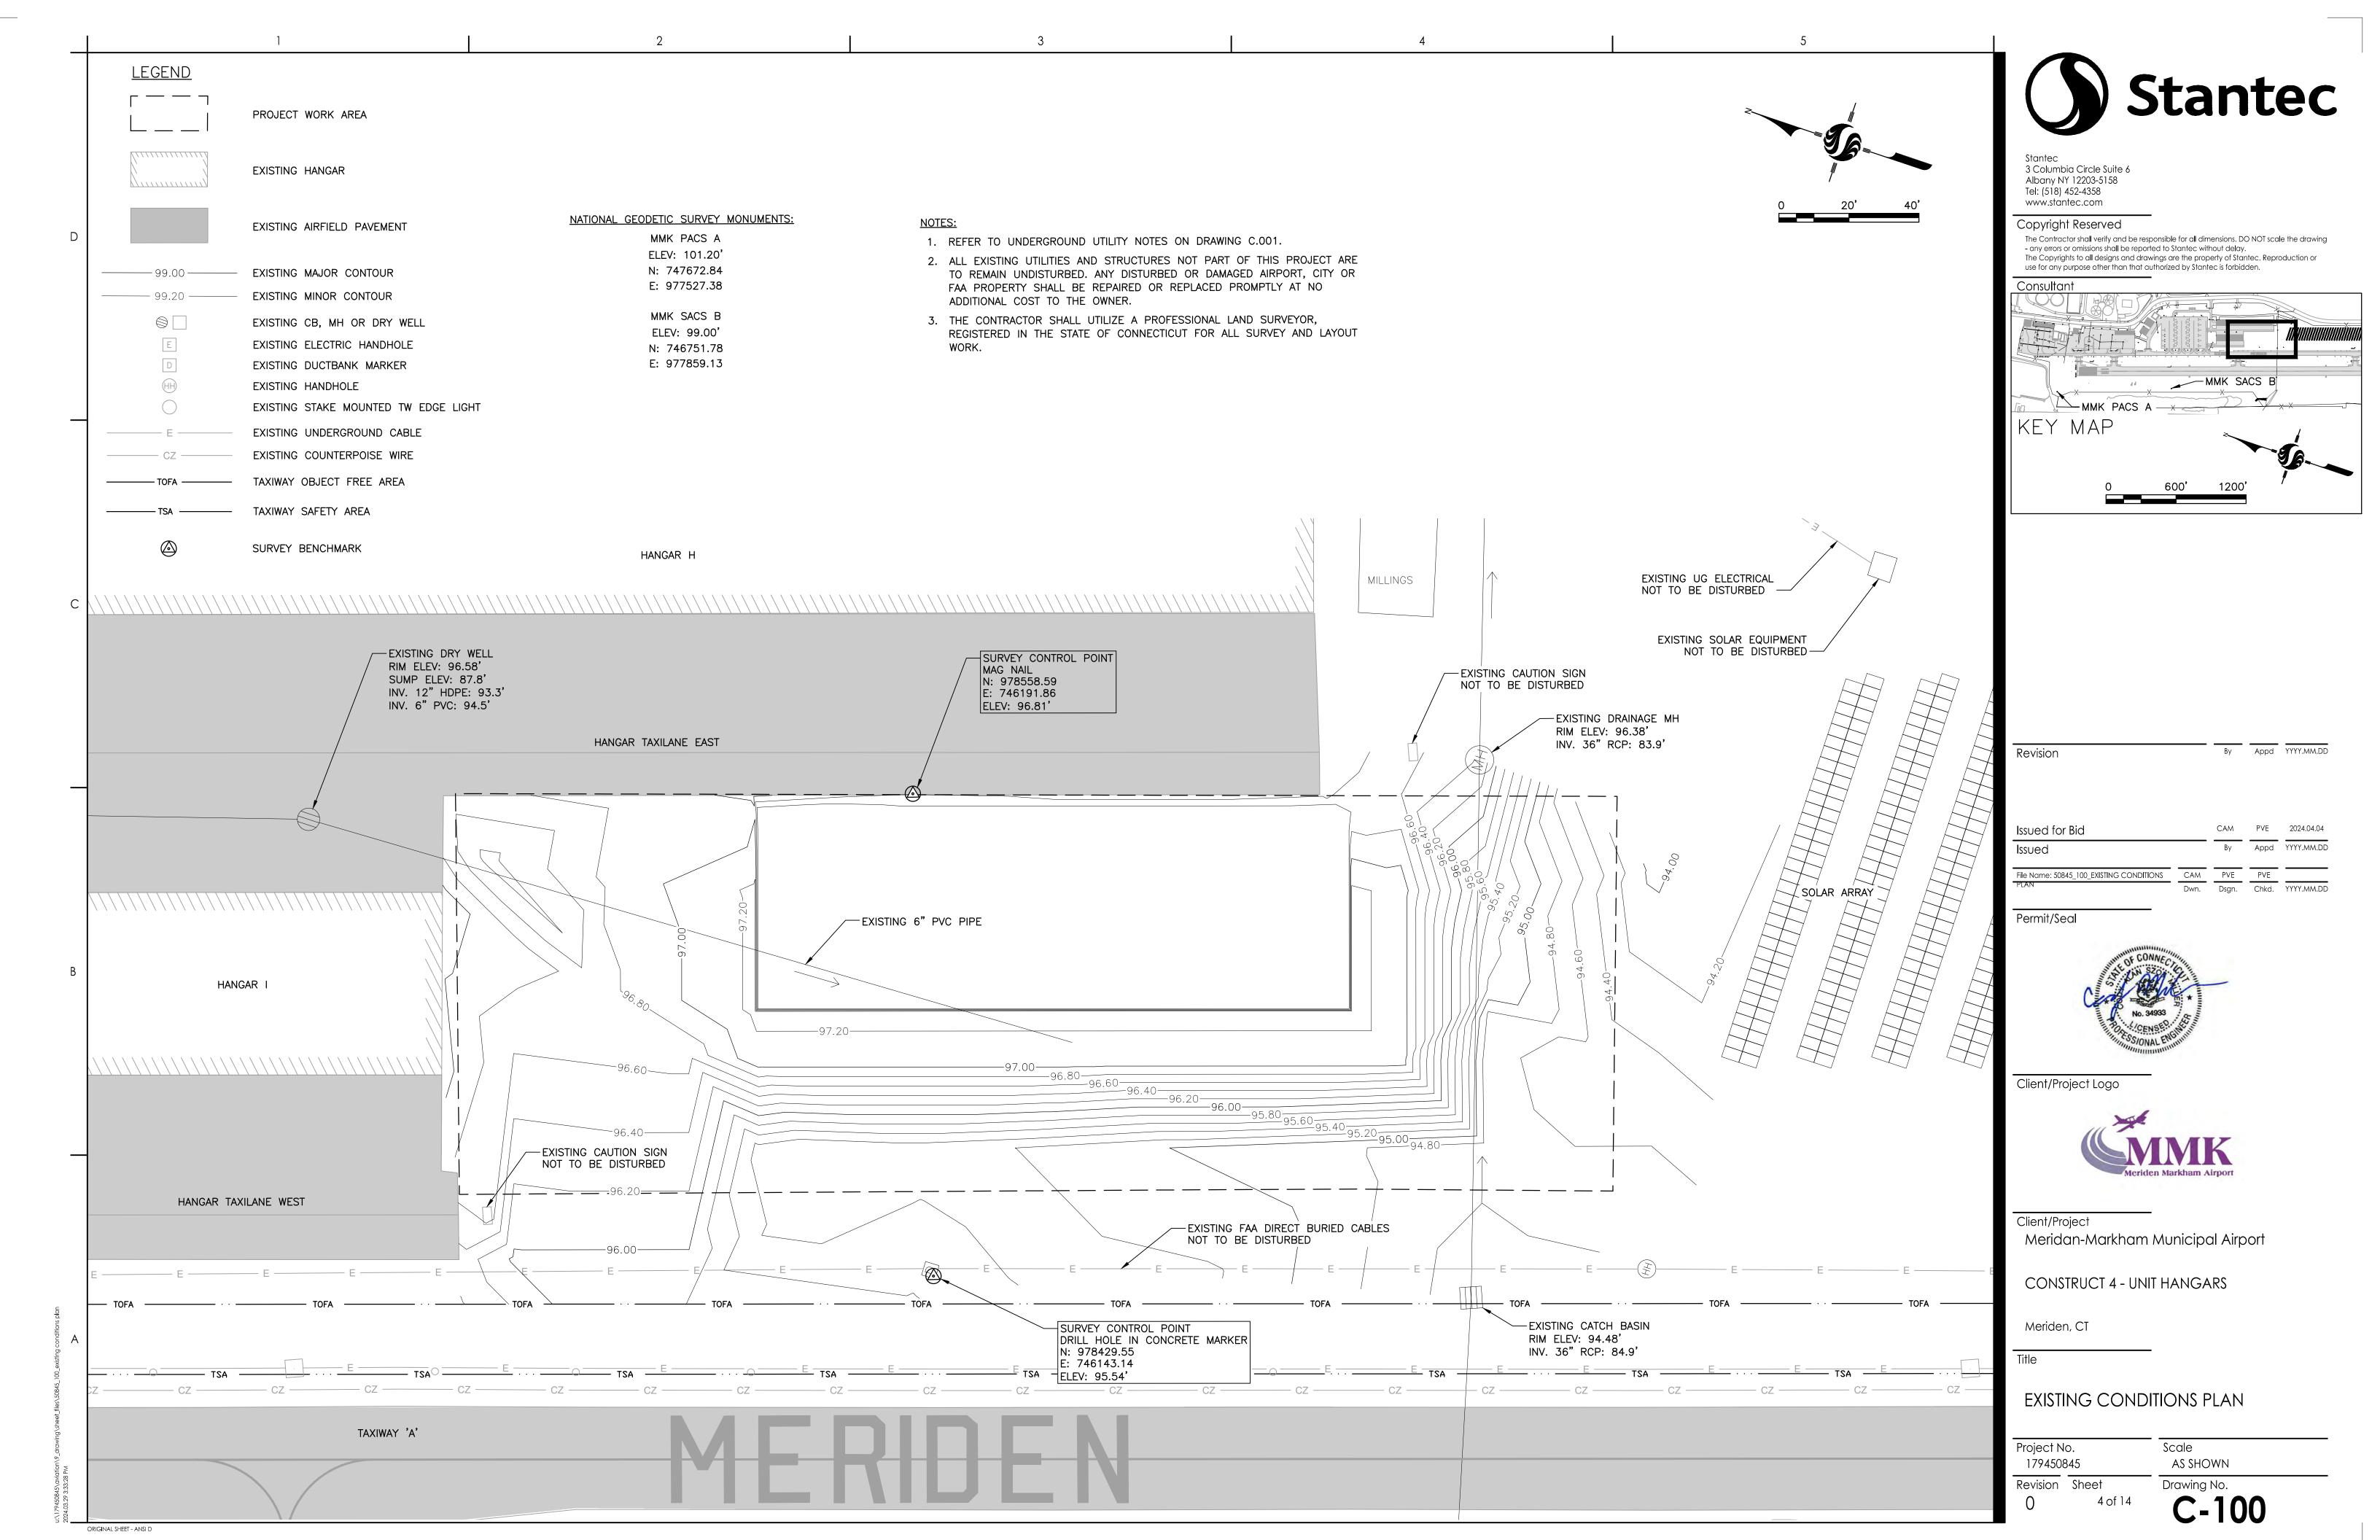

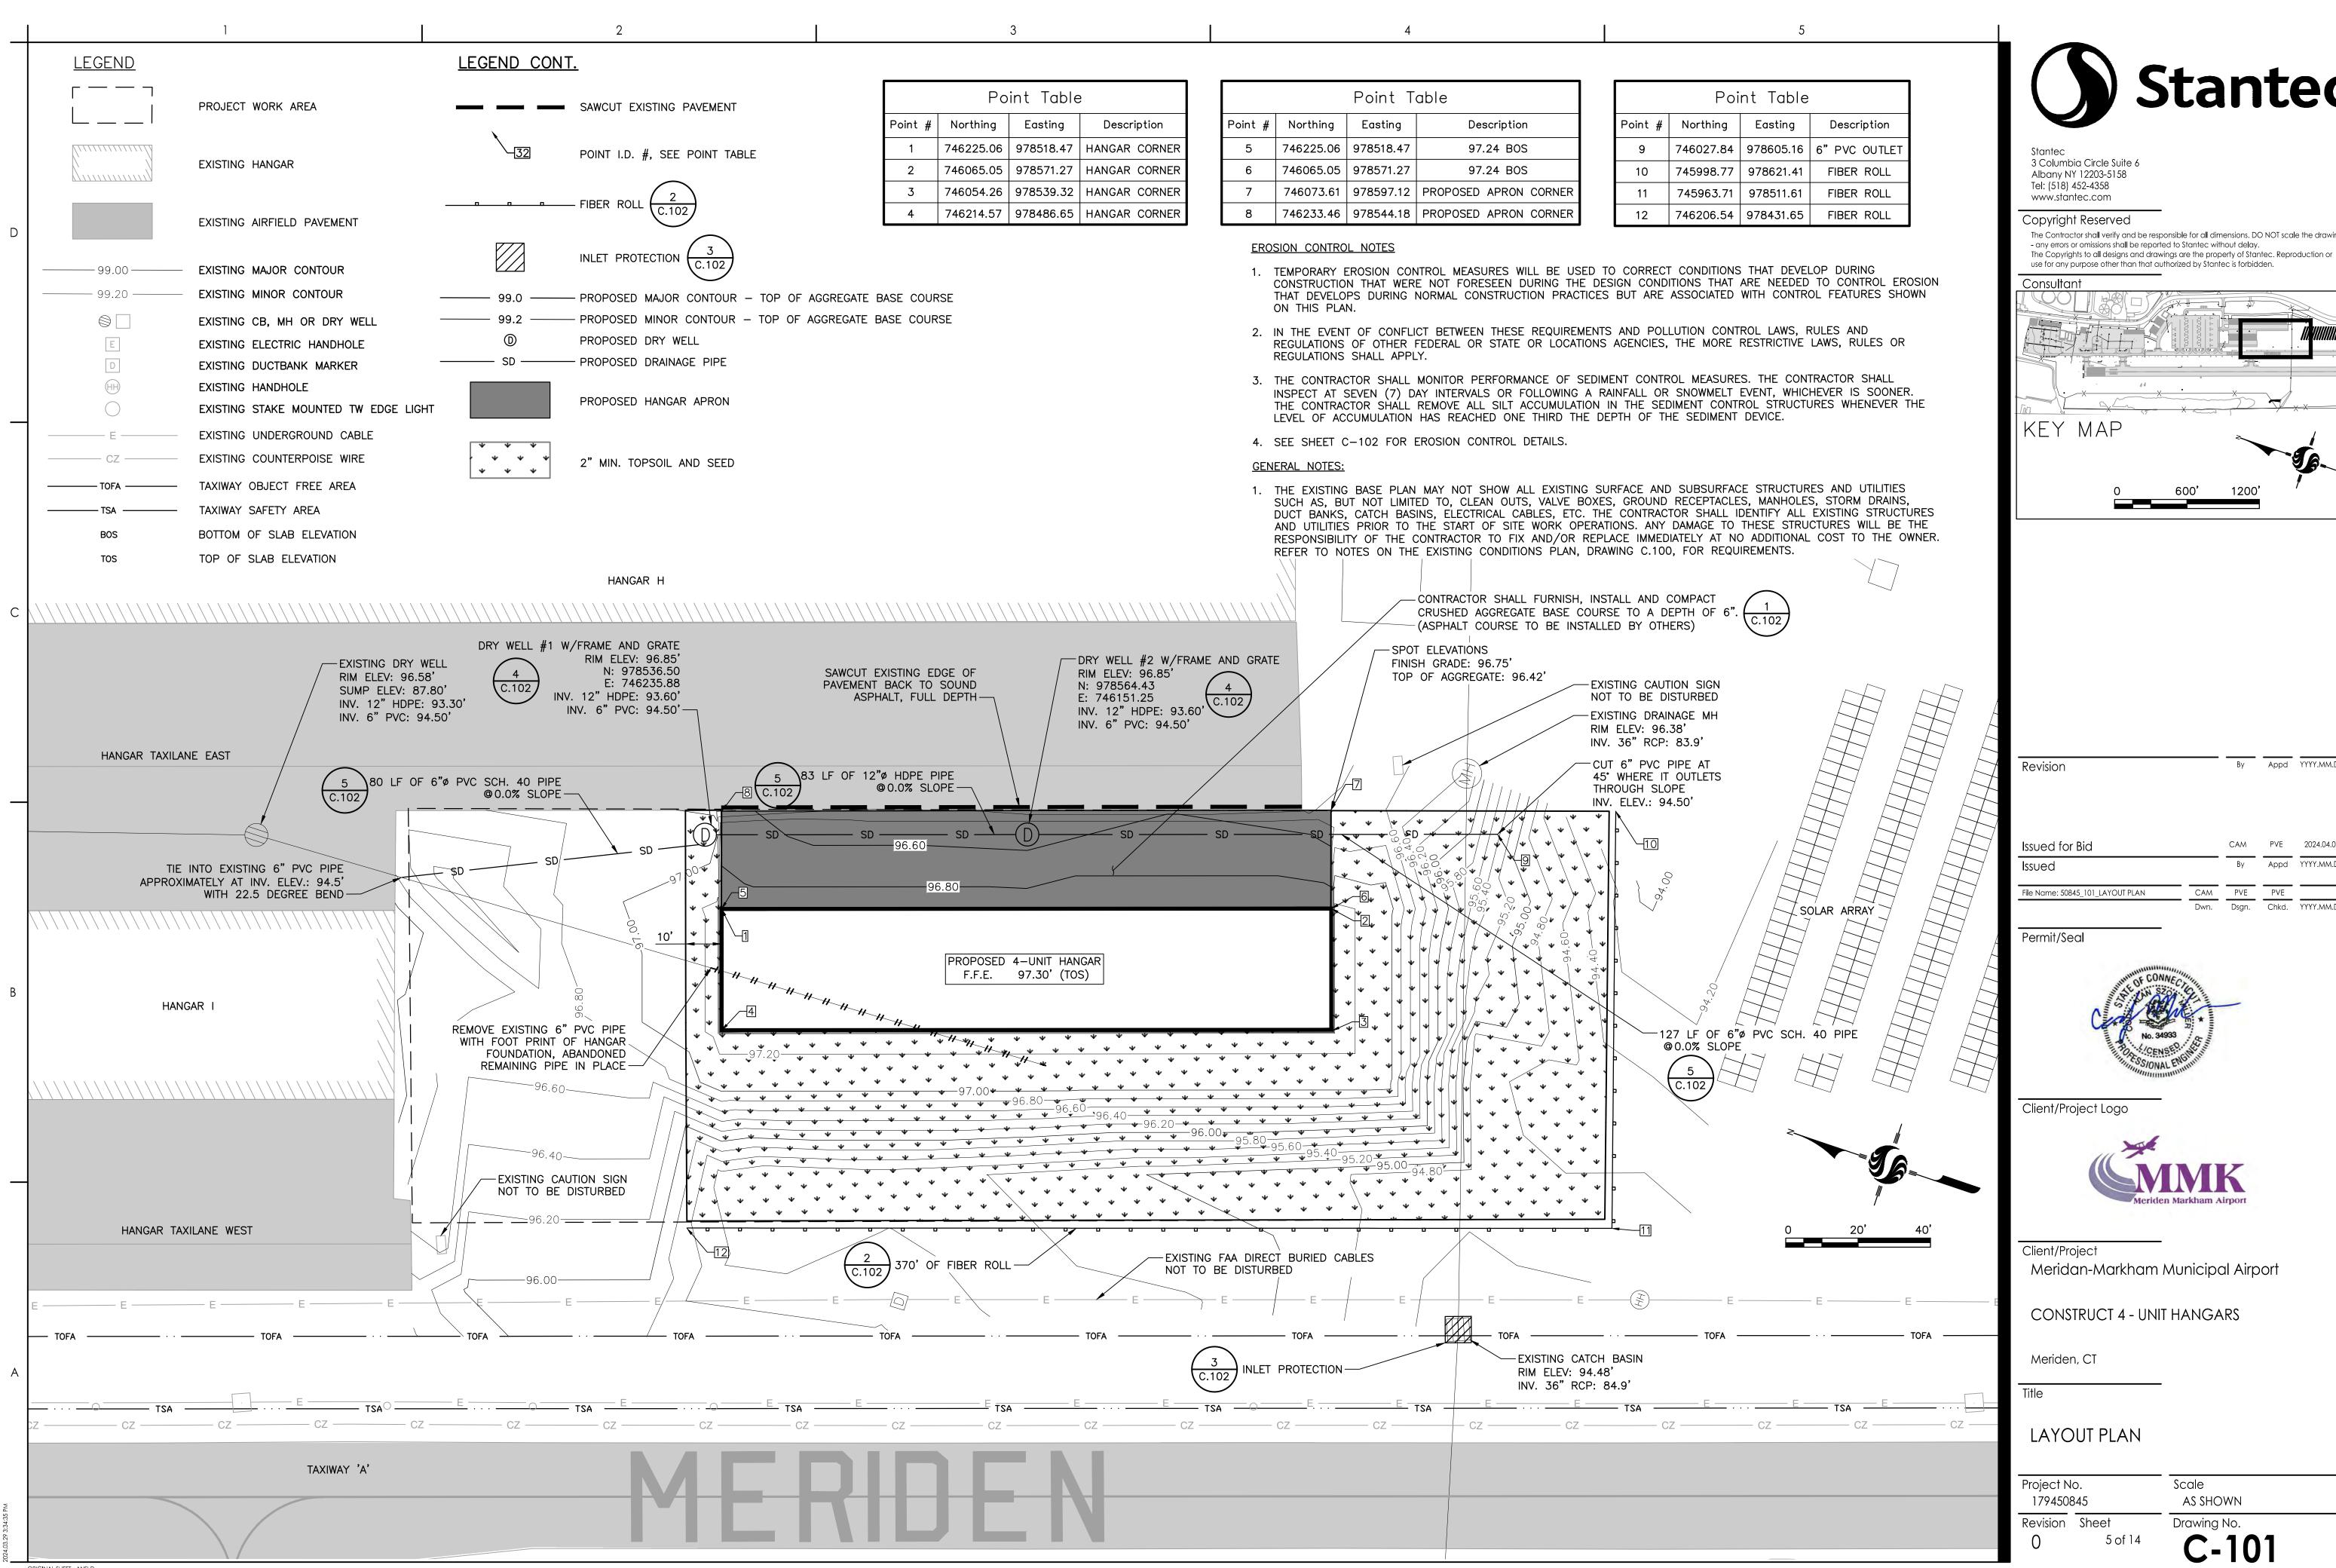




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Meridan-Markham Municipal Airport

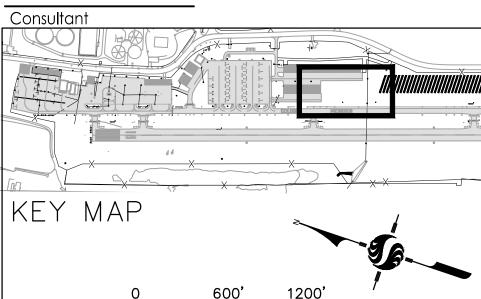
CONSTRUCT 4 - UNIT HANGARS

Meriden, CT

Title

TYPICAL SECTION AND CIVIL DETAILS
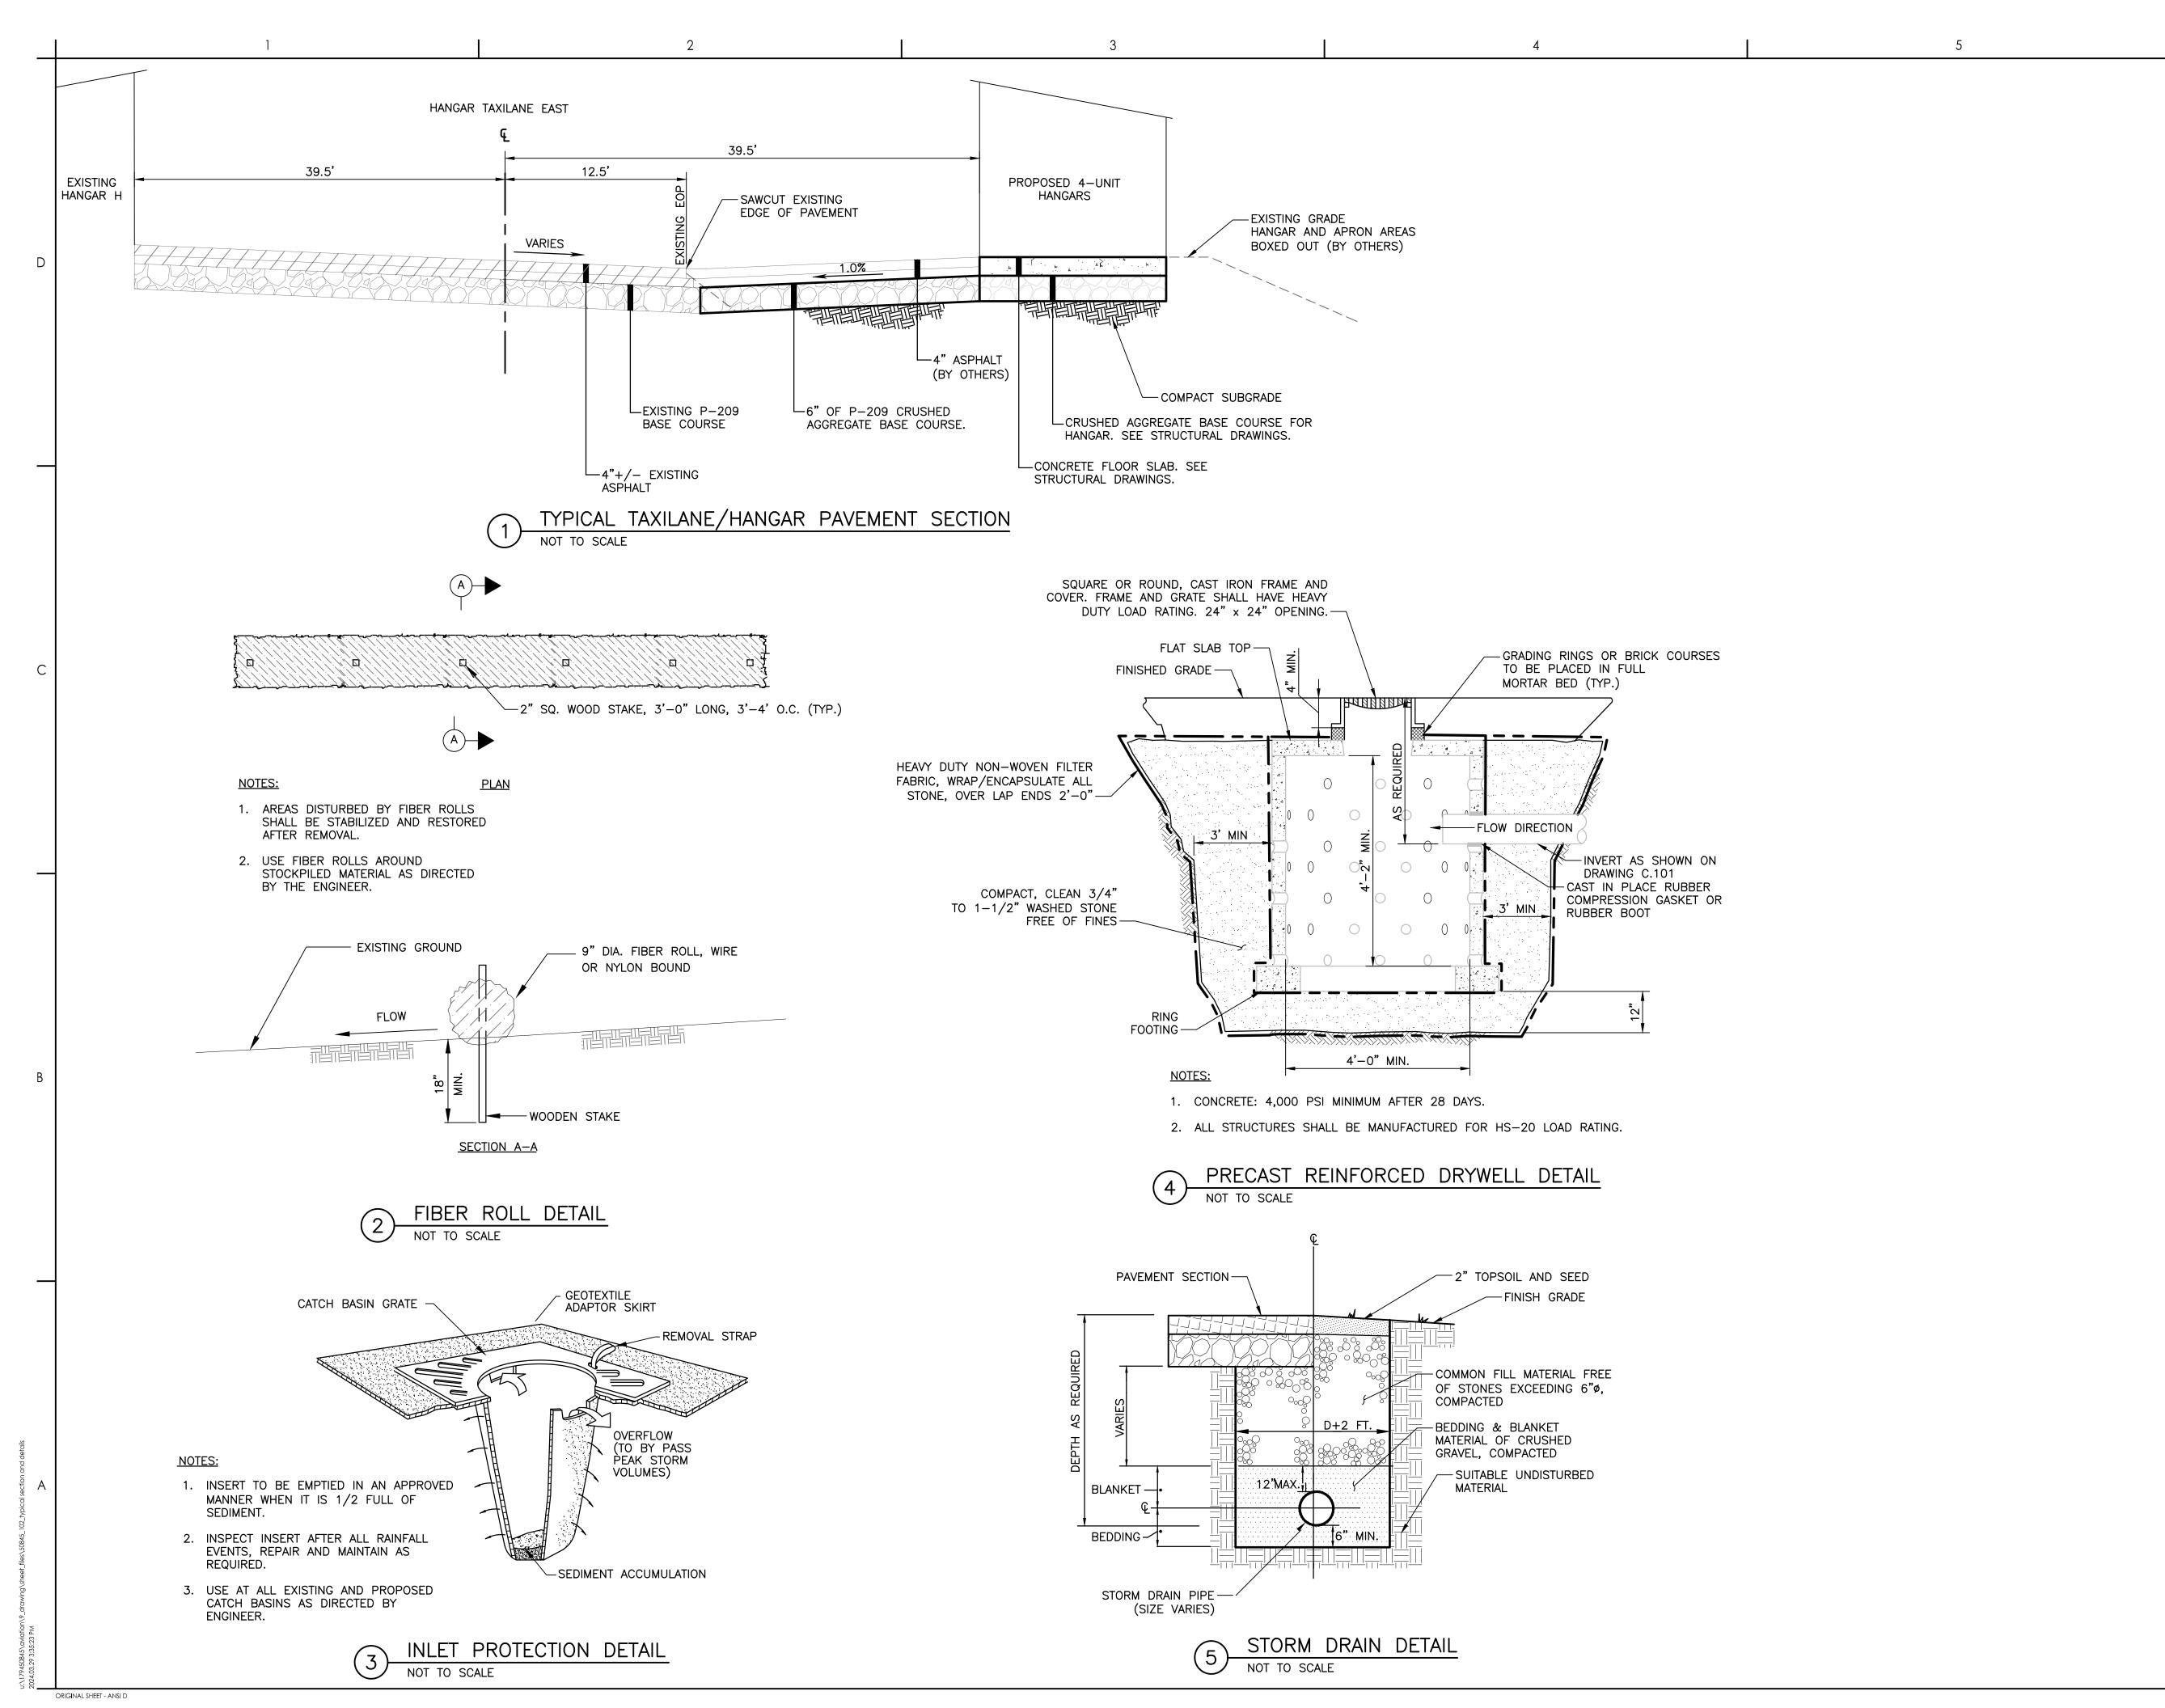
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Revision	Sheet	Drawing No.
0	6 of 14	C-102

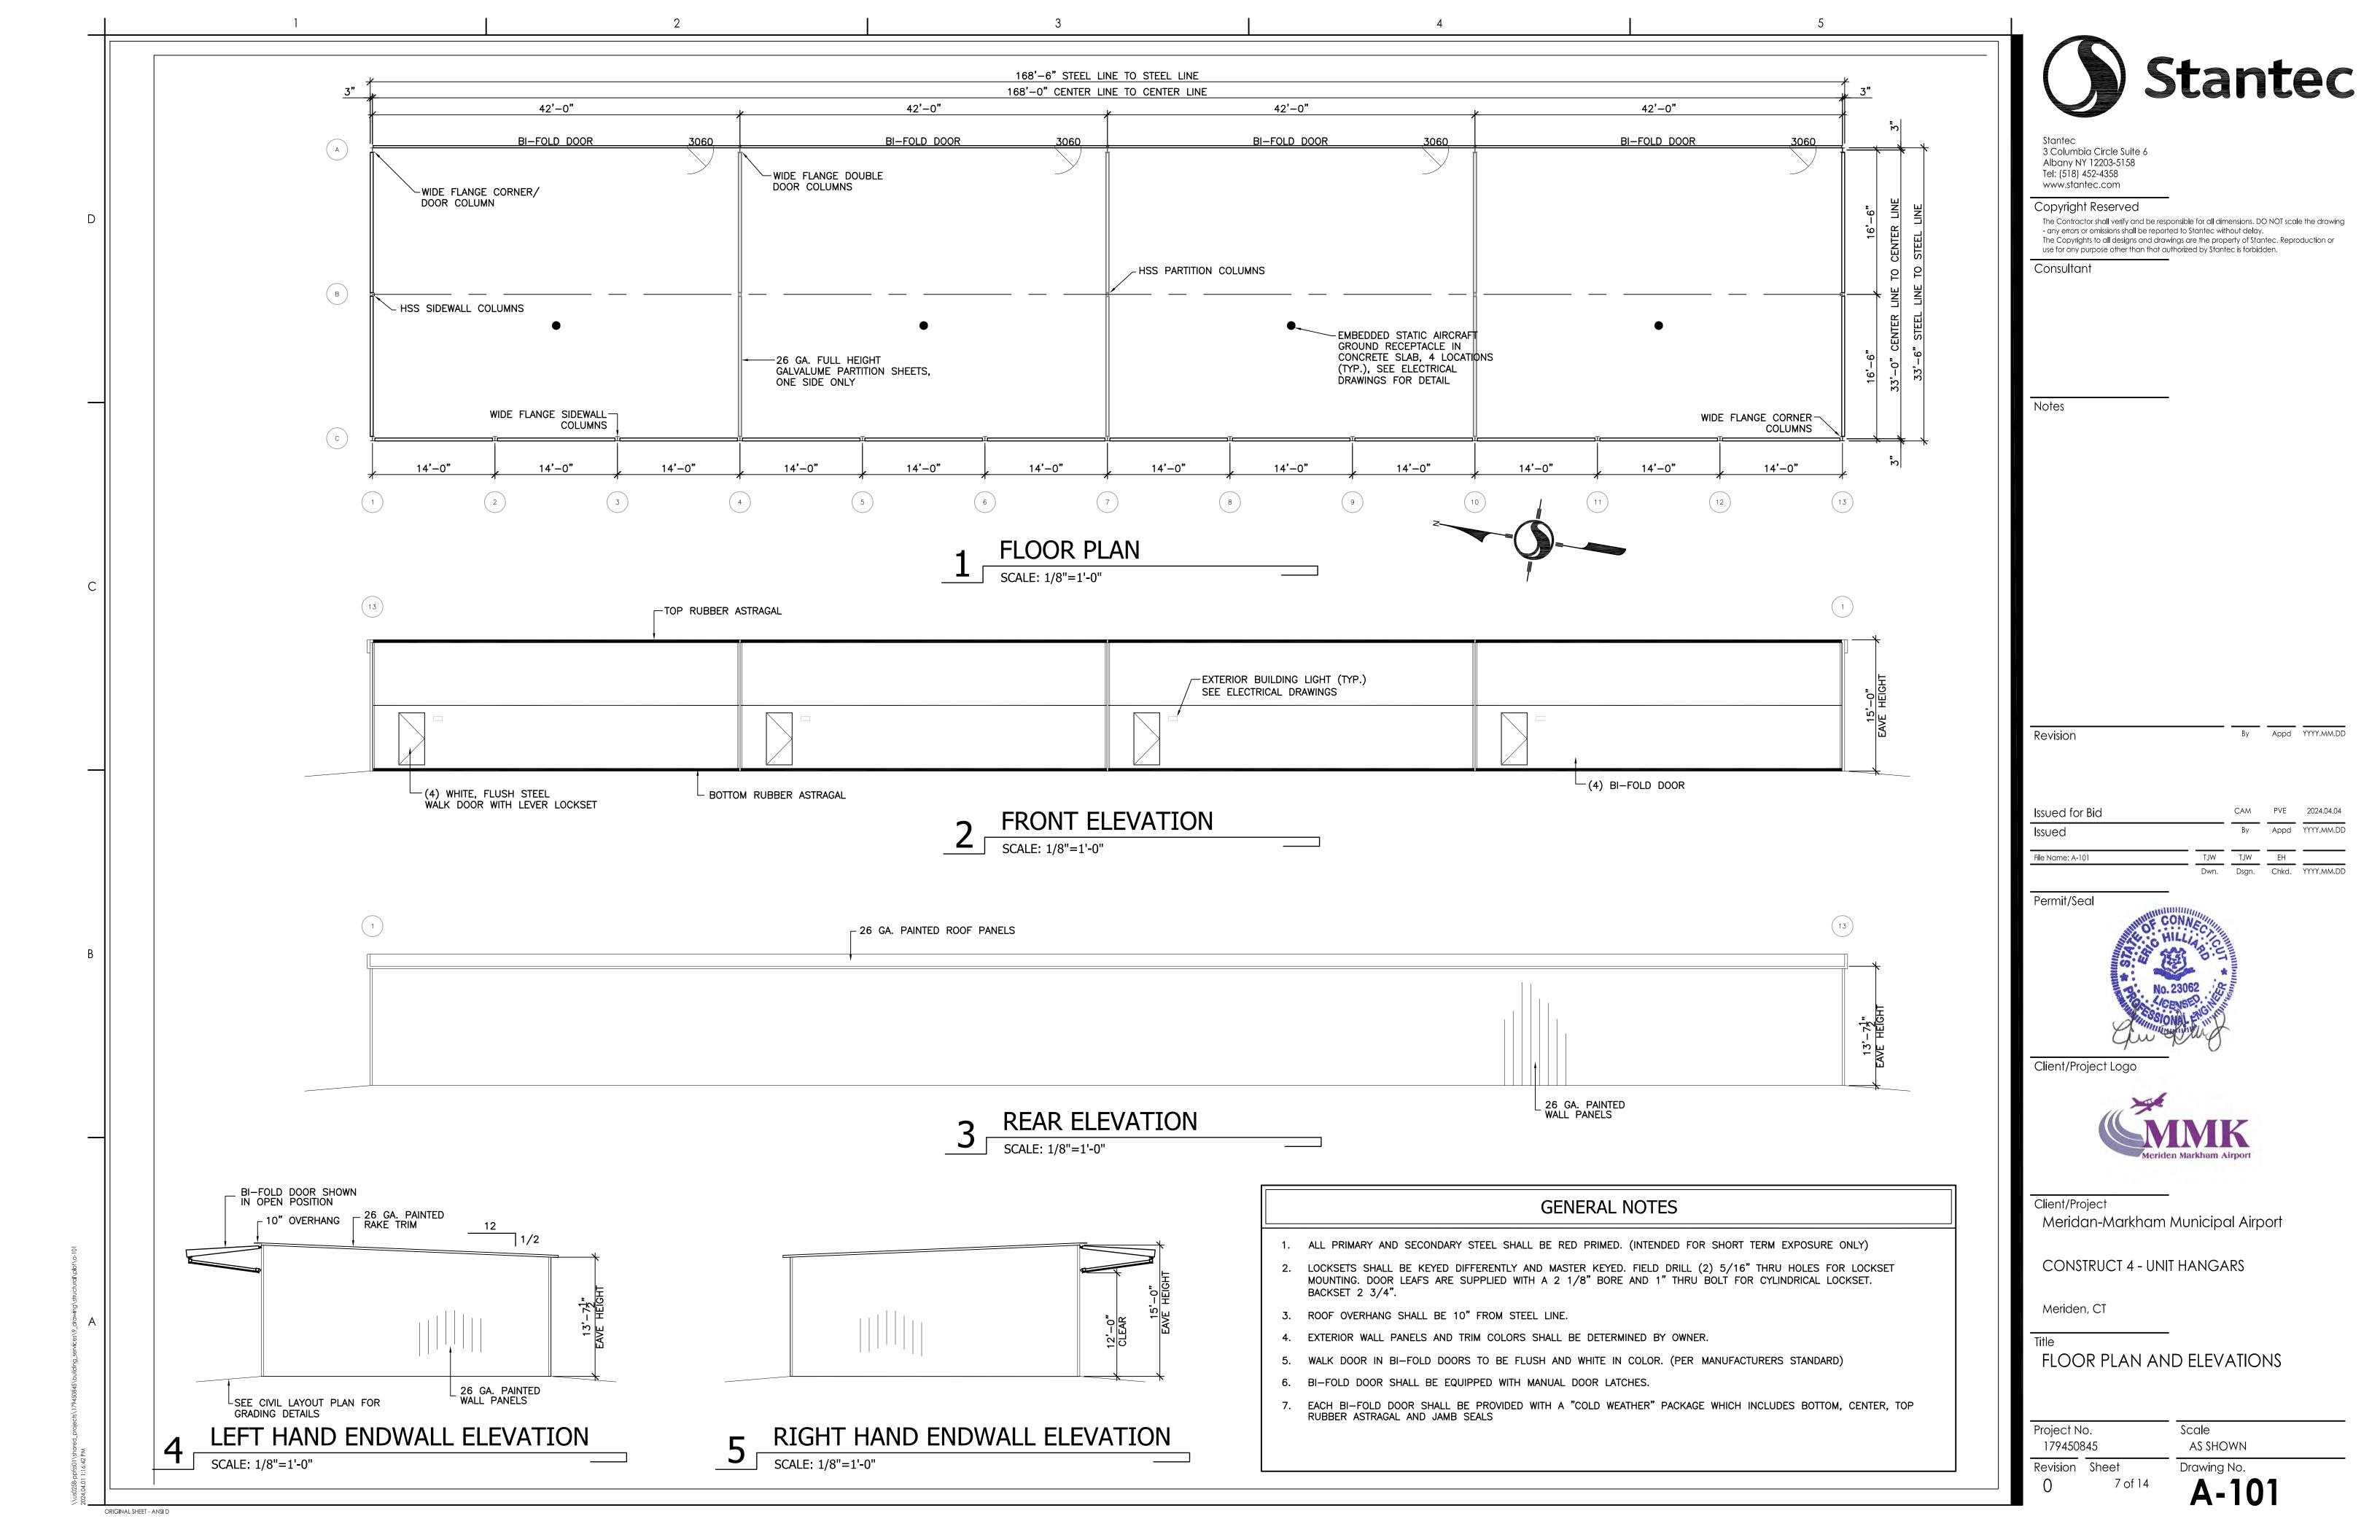

GENERAL NOTES	SYMBOL KEY		FOO	TING SCHEDULE	=
1. DETAILS GIVEN ARE TYPICAL AND APPLY TO SIMILAR CONDITIONS, U.N.O. 2. CONSTRUCTION SAFETY MEASURES, MEANS OF METHODS, AND THE COMPLIANCE WITH ALL OSHA LAWS IS THE	- DEPRESSED FOUNDATION WALL, ELEVATION -(1'-0"), SEE SECTION 2/S-201.	FOOTING TYPE	FOOTING SIZE	FOOTING DEPTH	FOOTING REINFORCING
RESPONSIBILITY OF THE CONTRACTOR.  3. CONTRACTOR SHALL NOTIFY THE ENGINEER OF ANY CONFLICTS / OMISSIONS IN CONTRACT DOCUMENTS FOR CLARIFICATION BEFORE PROCEEDING WITH WORK. CONTRACTOR SHALL NOT MAKE DEVIATIONS OR SUBSTITUTIONS WITHOUT		F1	4'-0" x 4'-0"	12"	4 — #5's E.W.
WRITTEN AUTHORIZATION FROM ENGINEER.	S IS THE —— DEPRESSED FOUNDATION WALL, ELEVATION —(1'-0"), SEE SECTION 2/S—201.	12"	4 — #5's E.W.		
PLAN NOTES	BID/AWARD NOTES	F3	6'-0" × 6'-0"	12"	7 — #5's E.W.
4 FINIOUED FLOOD FLEVATION T/O OLAD OZ ZOŻ				-	

1. FINISHED FLOOR ELEVATION T/O SLAB = 97.30'.

2. TOP OF FOUNDATION WALL ELEVATION = 97.30' UNLESS OTHERWISE NOTED.

3. TOP OF PIER ELEVATION = 97.30'.

2. TOP OF FOOTING ELEVATION = 93.8'.


4. SEE SHEET S-201 FOR TYPICAL FOUNDATION DETAILS

5. COORDINATE LOCATION, SIZE, SPECIAL REQUIREMENTS FOR OPENINGS IN CONCRETE WORK WITH ALL TRADES PRIOR TO POUR. SLEEVES TO BE SUPPLIED AS REQUIRED BY OTHER CONTRACTS & INSTALLED UNDER C—CONTRACT.

PIER AND FOOTING DESIGN IS SUBJECT TO DIMENSIONAL AND REINFORCEMENT CHANGES AFTER REVIEW OF THE HANGAR BUILDING SHOP DRAWINGS AND CALCULATIONS.

DO NOT SUBMIT CONCRETE REINFORCING SHOP DRAWINGS, BEGIN EXCAVATION OR PERFORM CONCRETE WORK, UNTIL FINAL STAMPED FOUNDATION DESIGN HAS BEEN PROVIDED BY THE ENGINEER.

NOTE: FOR PIER SIZES AND REINFORCEMENT REFER TO DETAIL 4/S-201.

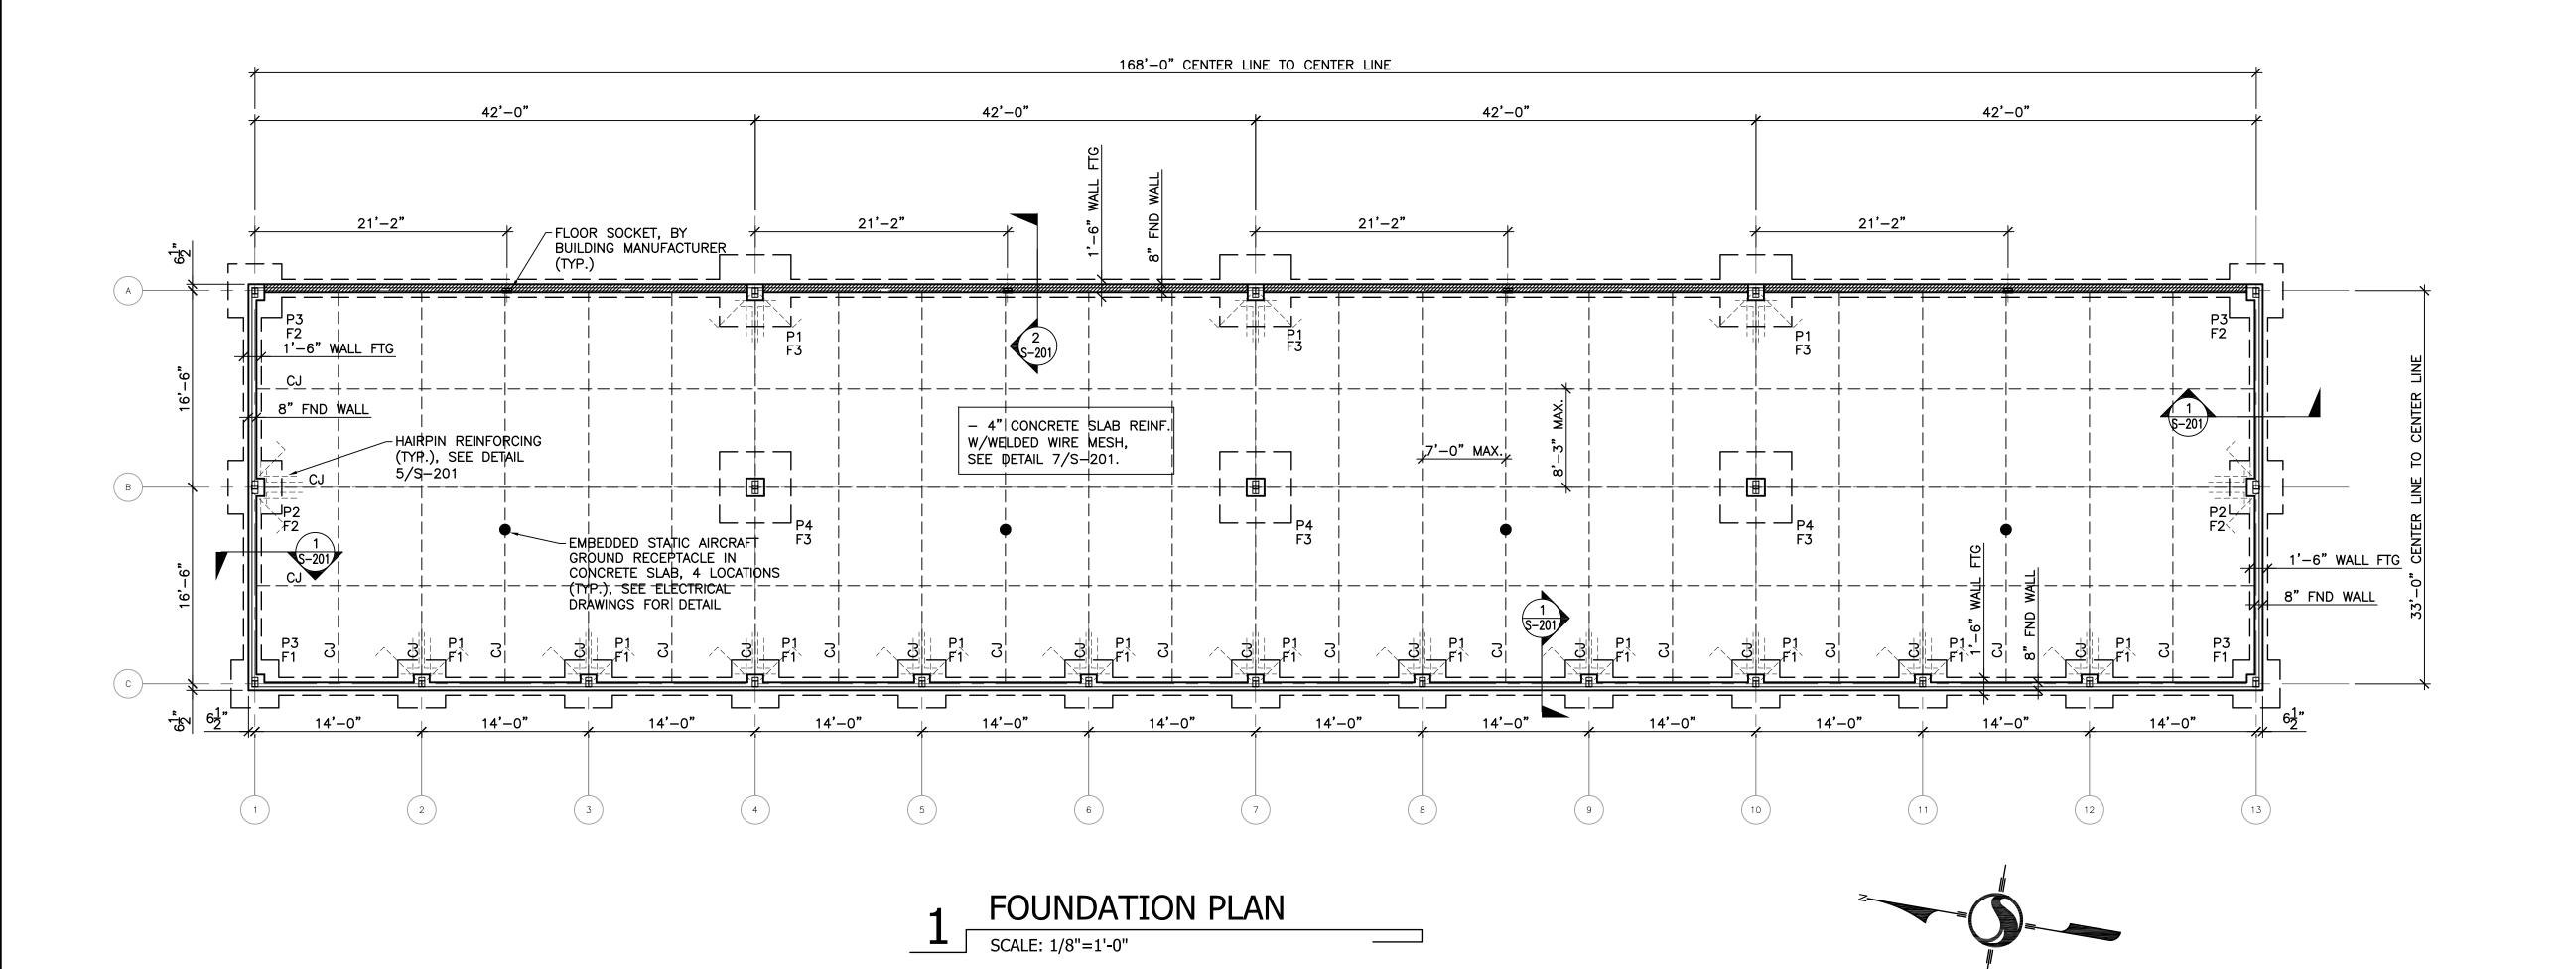

Stanted

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 File Name: S-101
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Client/Project Logo



Client/Project

Meridan-Markham Municipal Airport

CONSTRUCT 4 - UNIT HANGARS

Meriden, CT

Title

FOUNDATION PLAN

Project No.
179450845


Revision Sheet

Scale
AS SHOWN
Drawing No.

8 of 14 **S-101** 

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ORIGINAL SHEET - ANSI D

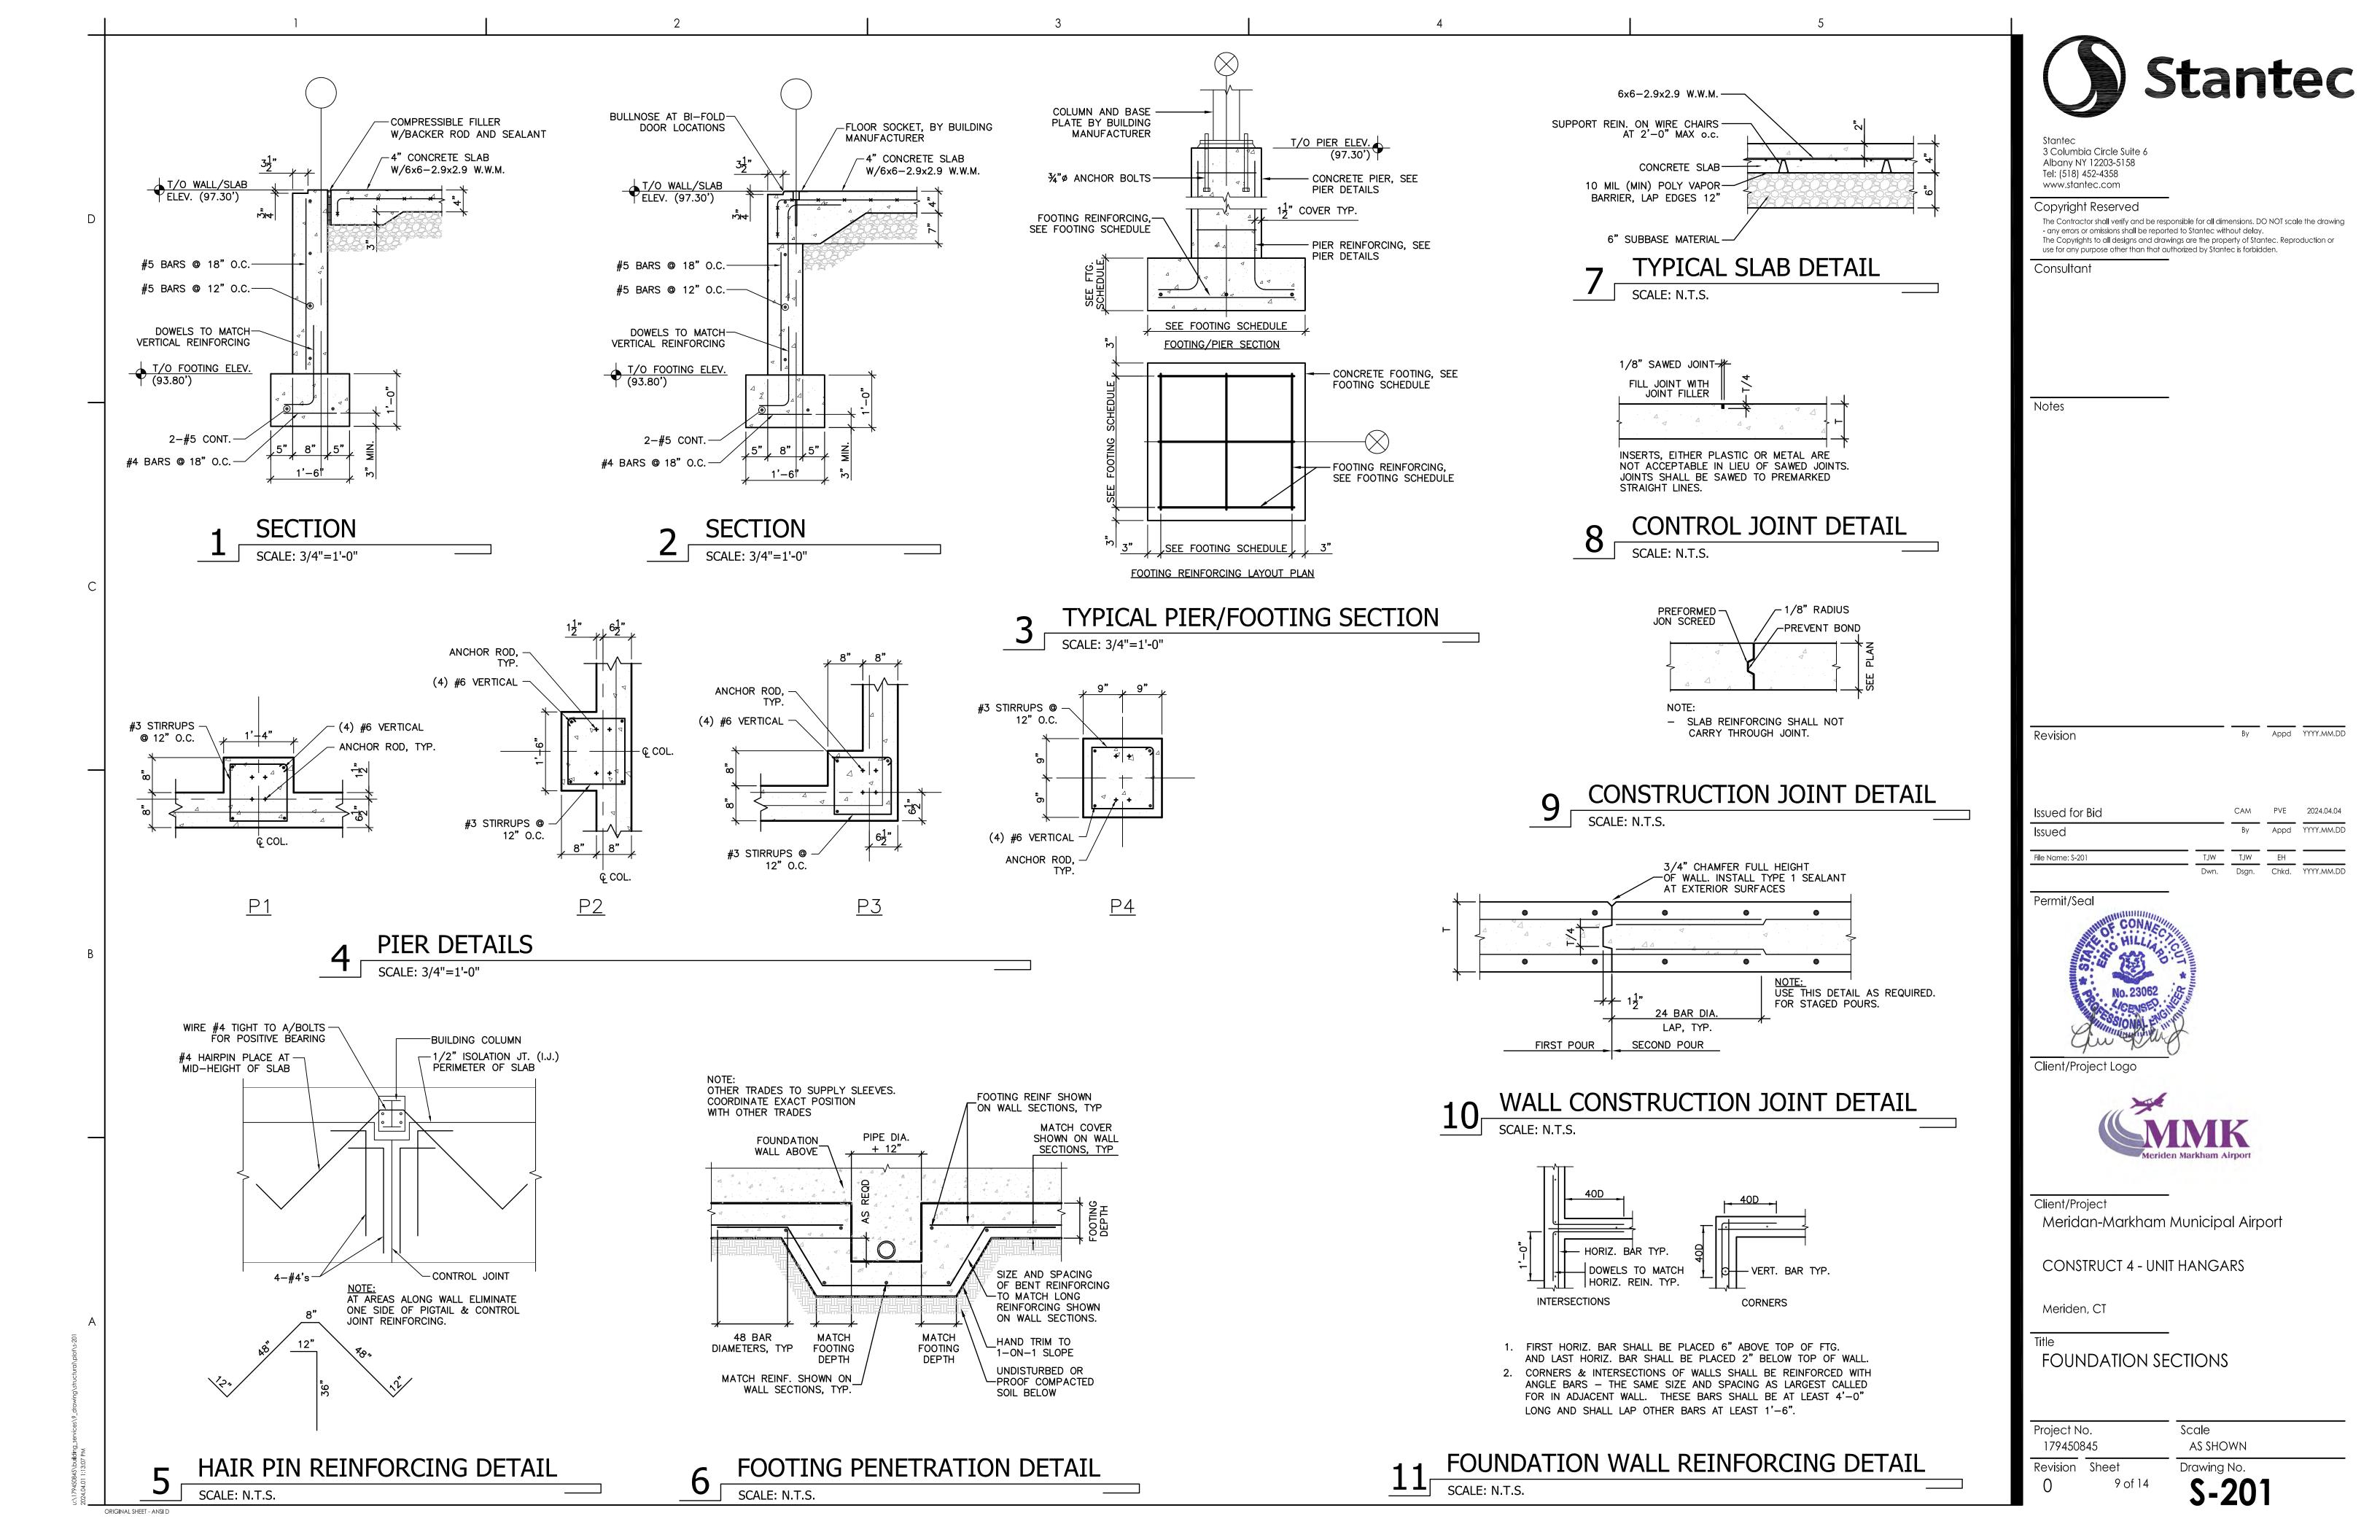

ELECTRICAL GENERAL NOTES ALL GENERAL NOTES, SYMBOL LIST & DETAILS ARE TO BE CONSIDERED AS APPLICABLE TO ALL ELECTRICAL DRAWINGS FOR THIS PROJECT. SYMBOLS AND ABBREVIATIONS SHOWN ON THIS SHEET ARE FOR REFERENCE ONLY AND DO ACU NOT INDICATE THEIR INCORPORATION IN THE DESIGN. AFF AFG ALL WORK PERFORMED ON THIS CONTRACT SHALL BE DONE IN A NEAT AND WORKMANLIKE MANNER AND SHALL BE IN COMPLIANCE WITH NEC, NFPA, IBC, OSHA, AND ALL APPLICABLE STATE AND LOCAL CODES AND ORDINANCES. THESE DRAWINGS ARE, IN GENERAL, MADE TO SCALE BUT ALL MEASUREMENTS SHALL BE TAKEN FROM FIGURED DIMENSIONS, AND NOT BY SCALING. THE ELECTRICAL CONTRACTOR SHALL CONFER WITH ALL OTHER TRADES CR RELATIVE TO THE LOCATION OF APPARATUS AND EQUIPMENT AND SELECT LOCATIONS SO AS NOT TO CONFLICT WITH WORK OF OTHER TRADES. CLF CT LIGHTING FIXTURE MANUFACTURERS NAME & MODEL NUMBER ARE USED FOR CTV DESCRIPTIVE PURPOSES ONLY AND ARE INTENDED TO INDICATE THE STANDARD OF MATERIAL OR ARTICLES REQUIRED. CUH ALL EQUIPMENT SHOWN ON THESE DRAWINGS IS INTENDED TO BE GENERALLY CWP REPRESENTATIVE OF THE EQUIPMENT WHICH WILL BE INSTALLED UNDER THIS DT CONTRACT, BUT IT SHALL NOT BE ASSUMED THAT THE DRAWINGS INDICATE DW THE SPECIFIC CONFIGURATION, ARRANGEMENT OR POINTS OF CONNECTION OF DWG THE ACTUAL EQUIPMENT UNLESS NOTED OTHERWISE. CIRCUIT BREAKERS USED FOR LIGHTING CIRCUITS SHALL BE SWITCH DUTY E.C. RATED AND APPROVED FOR USE WITH FIXTURES. CIRCUIT BREAKERS EDH USED FOR HVAC AND REFRIGERATION EQUIPMENT SHALL BE "HACR" RATED. ALL HOME RUNS FOR LIGHTING OR POWER CIRCUITS LONGER THAN 150 FEET SHALL BE INCREASED ONE SIZE. (IE: #12 TO #10). EWC EΧ ALL BRANCH CIRCUIT AND FEEDER CONDUCTORS SHALL BE SIZED FOR THE FACP O.C.D. RATING FOR THAT CIRCUIT ACCORDING TO NEC ART 310 UNLESS OTHERWISE INDICATED ON THESE DRAWINGS. IN NO CASE SHALL CONDUCTORS SMALLER THAN NO. 12 AWG BE USED FOR POWER OR LIGHTING CIRCUITS. FLA 10. PROVIDE 3/8" NYLON ROPE IN ALL EMPTY SERVICE RACEWAYS. GD **GFCI** 11. ALL SLEEVES AND OTHER PENETRATIONS THRU FIRE RATED ASSEMBLIES SHALL GND BE SEALED AFTER CABLE INSTALLATION WITH A FIRE RETARDANT COMPOUND. GRC 12. THE CONTRACTOR IS RESPONSIBLE FOR FIRESTOPPING AROUND ALL CONDUITS, CABLES AND ELECTRICAL EQUIPMENT AT ALL PARTITIONS PIERCED PER NEC 300.21 AND IBC. 13. THE CONTRACTOR IS RESPONSIBLE FOR MEETING ALL SEISMIC REQUIREMENTS FOR THE INSTALLATION OF ELECTRICAL EQUIPMENT UNDER IBC 14. GROUNDING SHALL BE PER N.E.C. ARTICLE 250, INSTALL GROUNDING CONDUCTORS WITH ALL FEEDERS AND BRANCH CIRCUITS. IBC 15. ALL WIRING SHALL BE IN CONDUIT. 16. REMOVE EQUIPMENT, FIXTURES AND DEVICES THAT ARE NOT BEING REUSED INFRA-RED AND DISCARD. OWNER HAS THE OPTION TO KEEP ANY MATERIAL DESIRED. KILOWATT EXISTING FIXTURES SCHEDULED FOR REUSE SHALL BE CLEANED. KWH KILOWATT HOUR 17. PROVIDE ARC FLASH LABELS ON EQUIPMENT AS REQUIRED BY NPFA 70 - ART. LONG/INSTANTANEOUS/GROUND FAULT LTG LIGHTING 18. PROVIDE AVAILABLE FAULT CURRENT VALUES AND DATE AS REQUIRED BY NFPA MB MAIN BREAKER 70 - ART. 110.24. UTILITY SHALL PROVIDE THESE VALUES (2 CYCLE SYMMETRICAL METAL CLAD MECHANICAL CONTRACTOR MCA MINIMUM CIRCUIT AMPACITY 19. WHERE THE FAA AND CSI SPECIFICATIONS DIFFER, THE MORE STRINGENT REQUIREMENT SHALL BE REQUIRED. MAIN DISCONNECT MAIN DISTRIBUTION PANEL MAN HOLE / METAL HALIDE MINERAL INSULATED MLO MAIN LUGS ONLY MMC MAINE MEDICAL CENTER MOUNTED MW MICROWAVE NOT APPLICABLE NORMALLY CLOSED NEC NATIONAL ELECTRICAL CODE (NFPA-70) NOT FUSED NFPA NATIONAL FIRE PROTECTION ASSOCIATION NIC NOT IN CONTRACT N**I**GHT LIGHT NON METALLIC NORMALLY OPEN NTS NOT TO SCALE OC OVER COUNTER OUTLET OCD OVERCURRENT DEVICE OSHA PULL BOX OCCUPATIONAL SAFETY AND HEALTH ADMINISTRATION POTENTIAL TRANSFORMER RECP RECEPTACLE REF REFRIGERATOR REQ'D REQUIRED RETURN FAN RGE RGS RIGID GALVANIZED STEEL CONDUIT RANGE HOOD SUPPLY FAN SOLID NEUTRAL TBD TO BE DETERMINED TAMPER PROOF TELEVISION TYP TYPICAL UNDER COUNTER UNIT HEATER UNO UNLESS NOTED OTHERWISE WEATHERPROOF INSTALL WITH "WIREMOLD" XFMR TRANSFORMER

#### GENERAL ABBREVIATIONS PANEL & CIRCUIT SYMBOLS

TIONS	DESCRIPTIONS	SYMBOLS	DESCRIPTIONS	DESCRIPTIONS
		SYMBOLS		
J	AIR CONDITIONING UNIT	<del>↓ □                                   </del>	PANELBOARD - FLUS	H MOUNTED AT 6'-6" TO TOP.
=	ABOVE FINISHED FLOOR		DANELBOARD - SLIPE	FACE MOUNTED AT 6'-6" TO TOP.
3	ABOVE FINISHED GRADE		FAINLLDOAND - SON	ACL MOUNTED AT 0-0 TO TOP.
J	AIR HANDLING UNIT	LP1-3 (PAR)		
	AMPERE INTERRUPTING CAPACITY	│	INDICATES PARTIAL	CIRCUIT
	CONDUIT		INDICATES CIRCUIT I	
	CONDUIT SLEEVE		INDICATES PANEL	
	CIRCUIT BREAKER	<b>&gt;</b>		O EQUIPMENT; ARROW INDICATES HOMERUN TO
	CENTER LINE		PANELBOARD OR AS	
	CASEWORK RECESSED OUTLET			N CONDUIT RUN IN FLOOR OR UNDERGROUND.
-	CURRENT LIMITING FUSE		INDICATES CONTROL	_ WIRING BY ELECTRICAL
	CURRENT TRANSFORMER			
/	CABLE TELEVISION		TRANSFORMER, SIZE	E & TYPE AS INDICATED
	CONDENSING UNIT		ILINICTION DOV SIZE	ED IN ACCORDANCE WITH NEC - "C"
4	CABINET UNIT HEATER	[ - L U U U U U U U U U U U U U U U U U U	INDICATES MOUNTIN	
P	CONDENSER WATER PUMP	ا بً		E DISCONNECT SWITCH
	DISTRIBUTION TRANSFORMER	☐ 30NF	30 = AMPACITY. VOL	
1	DISHWASHER	40 60	3 POLE FUSIBLE DISC	
G	DRAWING	<u> </u>	60 = CLIP SIZE, 40 = F	
3	ELECTRIC BASEBOARD HEATER	,	VOLTAGE AS REQ'D	
•	ELECTRICAL CONTRACTOR	l □ ¹ <sub>3R</sub>	3 POLE WEATHERPR	OOF DISCONNECT SWITCH SIZE & CONFIGURATION
1	ELECTRIC DUCT HEATER		AS NOTED ABOVE	
	EXHAUST FAN	MS	MANUAL STARTER - S	SIZE AS REOLURED
1	ELECTRIC UNIT HEATER	[WO]	WANDAL STAILTER -	SIZE AS NEGOTIVED
C	ELECTRIC WATER COOLER	Ф	MOTOR, HP AS INDIC	ATED COORDINATE W/ ACTUAL EQUIPMENT
	EXISTING EQUIPMENT (AS NOTED)	У У	FURNISHED.	
Р	FIRE ALARM CONTROL PANEL		COMPINATION MACA	IETIC STARTER - NEMA SIZE AS REQUIRED
)	FURNISHED BY OWNER			OVIDE W/ H-O-A SWITCH AND GREEN RUN LIGHT
	FAN COIL		ON COVER.	SVIDE WITH STROME STREET CONTENTS
4	FULL LOAD AMPS	$\boxtimes$	MAGNETIC STARTER	- NEMA SIZE AS REQUIRED (MINIMUM SIZE 1)
	GARBAGE DISPOSER	_		WITCH AND GREEN RUN LIGHT ON COVER
CI -	GROUND FAULT CIRCUIT INTERRUPTING			TALLED BY ELECTRICAL CONTRACTOR. SIZE AS
)	GROUND		MOTOR CONTROLLE	R - FURNISHED WITH MOTOR.
j	GALVANIZED RIGID STEEL CONDUIT	ATS	AUTOMATIC TRANSF	ER SWITCH
	HUMIDIFIER		ILINICTION BOY IN AC	CCESSIBLE LOCATION WITH FLEXIBLE CONDUIT
	HEAT DETECTOR	(J)	CONNECTION TO EQ	
	HAND HOLE HORSEPOWER / HEAT PUMP	_		
2	HIGH PRESSURE SODIUM	Yı		DUS LOCATION SEALING FITTING (U.L. LISTED FOR USE ONTAL CONDUIT RUNS).
) I	HEAT RECOVERY UNIT		VERTIONE ORTHORIZ	ONTAL CONDON NONO).
,	HIGH VOLTAGE			
Þ	HOT WATER CIRC. PUMP	1 101		MDOLC
3	INTERNATIONAL BUILDING CODE	LIGI	HTING SY	IVIDULO
•	ISOLATED GROUND			
	NEDA DED			

SYMBOLS	DESCRIPTIONS
	WALL MOUNTED EXTERIOR LIGHT
	LENSED LED STRIP - AS NOTED ON DRAWINGS ON DRAWINGS.
	LENSED LED STRIP - AS NOTED ON DRAWINGS ON DRAWINGS. SHADING DENOTES BATTERY BACKUP.
×	EMERGENCY EXIT SIGN, SEE LIGHTING SCHEDULE FOR SPECIFICATION.

# RECEPTACLE OUTLET SYMBOLS

LS DESCRIPTIONS
IS CIRCUIT CONTROL GROUP.
INDICATES MOUNTED AT 42" A.F.F. "GFI" INDICATES GFI OUTLET
(PROTECTS DOWNSTREAM RECEPTACLES ON SAME CIRCUIT.)
INDICATES DEVICE MOUNTED IN "WIREMOLD"
INDICATES DEVICE MOUNTED IN WIREMOLD INDICATES EXISTING
INDICATES EXISTING INDICATES TAMPER RESISTANT
INDICATES OVER COUNTER
INDICATES OVER COUNTER INDICATES WEATHER RESISTANT DEVICE IN A WEATHER PROOF IN-USE
COVER
WITH GROUND TERMINAL AT TOP. DEVICES SHALL BE HOSPITAL GRADE, SEE
WITH GROUND TERMINAL AT TOT: DEVIGES SHALL BE HOST THAL GRADE, SEE
D SIMPLEX CONVENIENCE RECEPTACLE MOUNTED AT +18" OR AS NOTED.
I
DUPLEX RECEPTACLE OUTLET NEMA 5-20R, HEAVY DUTY.
MOUNTED AT +18" OR AS NOTED, SELF-ILLUMINATING, AND
BACKPLATE. DEVICES
SHALL BE RED WHEN CONNECTED TO CRITICAL OR EQUIPMENT
PANELS. QUADRUPLEX RECEPTACLE OUTLET (DOUBLE DUPLEX) NEMA 5-
20R, HEAVY DUTY. MOUNTED AT +18" OR AS NOTED, SELF-
ILLUMINATING, AND BACKPLATE. DEVICES SHALL BE RED WHEN
CONNECTED TO CRITICAL OR EQUIPMENT PANELS.
CONNECTED TO CIVITOAL OIL EQUIPMENT FANELS.
GF GFCI DUPLEX RECEPTACLE OUTLET
90 OLOUPSI FEXTILIZED MOLE COLLET
angle RANGE OUTLET NEMA 14-50R ("D" INDICATES DRYER OUTLET NEMA 14-30R
SPECIAL PURPOSE CONNECTION.
2 FUDODEAN COOK DUDIEV DECEDTA OLE
EUROPEAN 220V DUPLEX RECEPTACLE
N
FLOOR SINGLE RECEPTACLE OUTLET W/ COVER. NEMA 5-20R
-
FLOOR DUPLEX RECEPTACLE OUTLET W/ COVER. NEMA 5-20R
DW FLOOR SPECIAL PURPOSE OUTLET LETTER(S)

# LIGHT

	BESIDE SYMBOL INDICATES ACTUAL EQUIPMENT SERVED.					
LIG	HTING CONTROL SYMBOLS					
SYSMBOOR.GL	S DESCRIPTIONS					
WHENEVER P SWITCHES SH	OCATED IN THE SAME AREA SHALL BE GANGED UNDER COMMON PLATE PRACTICAL, GROUP SWITCHES, THERMOSTATS ETC. TOGETHER. HALL BE LOCATED ON STRIKE SIDE OF DOOR. ADJUST TO MINIMIZE CUT OF LE. LOWERCASE LETTER IS SWITCH CONTROL GROUP.					
\$	SINGLE POLE SWITCH MOUNTED AT +48" OR AS NOTED.					
<b>\$</b> <sup>3</sup> A	THREE WAY SWITCH MOUNTED AT +48" OR AS NOTED.	Revision		Ву	Appd	YYY
<b>\$</b> ™	SLIDE CONTROL DIMMER AT +48" OR AS NOTED, PROVIDE SWITCH FOR FIXTURES ACTUALLY SERVED.					
<b>₿</b> LXXX	LOW VOLTAGE SWITCH LIGHT MOUNTED AT +48" OR AS NOTED. SEE DETAILS FOR SWITCH CONFIGURATION(S)					
<b>\$</b> ₽	SINGLE POLE SWITCH W/ PILOT LIGHT MOUNTED AT +48" OR AS NOTED.	Issued for Bid		САМ	PVE	20
<b>\$</b> <sup>™</sup>	H.P. RATED MANUAL MOTOR STARTER (WEATHERPROOF WHERE OUTSIDE).			By	Appd	YYY
Sos osa	OS - DUAL TECH. OCCUPANCY SENSOR WALL SWITCH	Issued		Бу	Дрра	
"	OS2 - DUAL TECH. OCCUPANCY SENSOR TWO BUTTON/LOAD WALL SWITCH	File Name: 50845_E-501_ELEC_DTLS	НАВ	MLC	MK	
©S)	OCCUPANCY SENSOR (CEILING MOUNT). COMPATIBLE WITH ROOM CONTROLLER/ SWITCHING SYSTEM OR/AND LIGHTING CONTROL PANEL. 'H' DENOTES HIGH CEILING TYPE. 'R' DENOTES HVAC RELAY	Permit/Seal	Dwn.	Dsgn.	Chkd.	YYY
TYPE #	ROOM CONTROLLER (ABOVE CEILING MOUNT)					

Client/Project Logo

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Notes



Client/Project Meridan-Markham Municipal Airport

CONSTRUCT 4 - UNIT HANGARS

Meriden, CT

ELECTRICAL LEGEND AND GENERAL

Project No. 179450845 Revision Sheet 10 of 14

AS SHOWN Drawing No.


Scale


LRC - LOCAL SWITCH CONTROL. LDC - LOCAL DIMMING CONTROL.

NRC - NETWORK SWITCH CONTROL. NDC - NETWORK DIMMING CONTROL. THE # INDICATES NUMBER OF LOADS. SEE DETAILS.

UL LISTED 924 EMERGENCY CONTROL RELAY

ORIGINAL SHEET - ANSI D

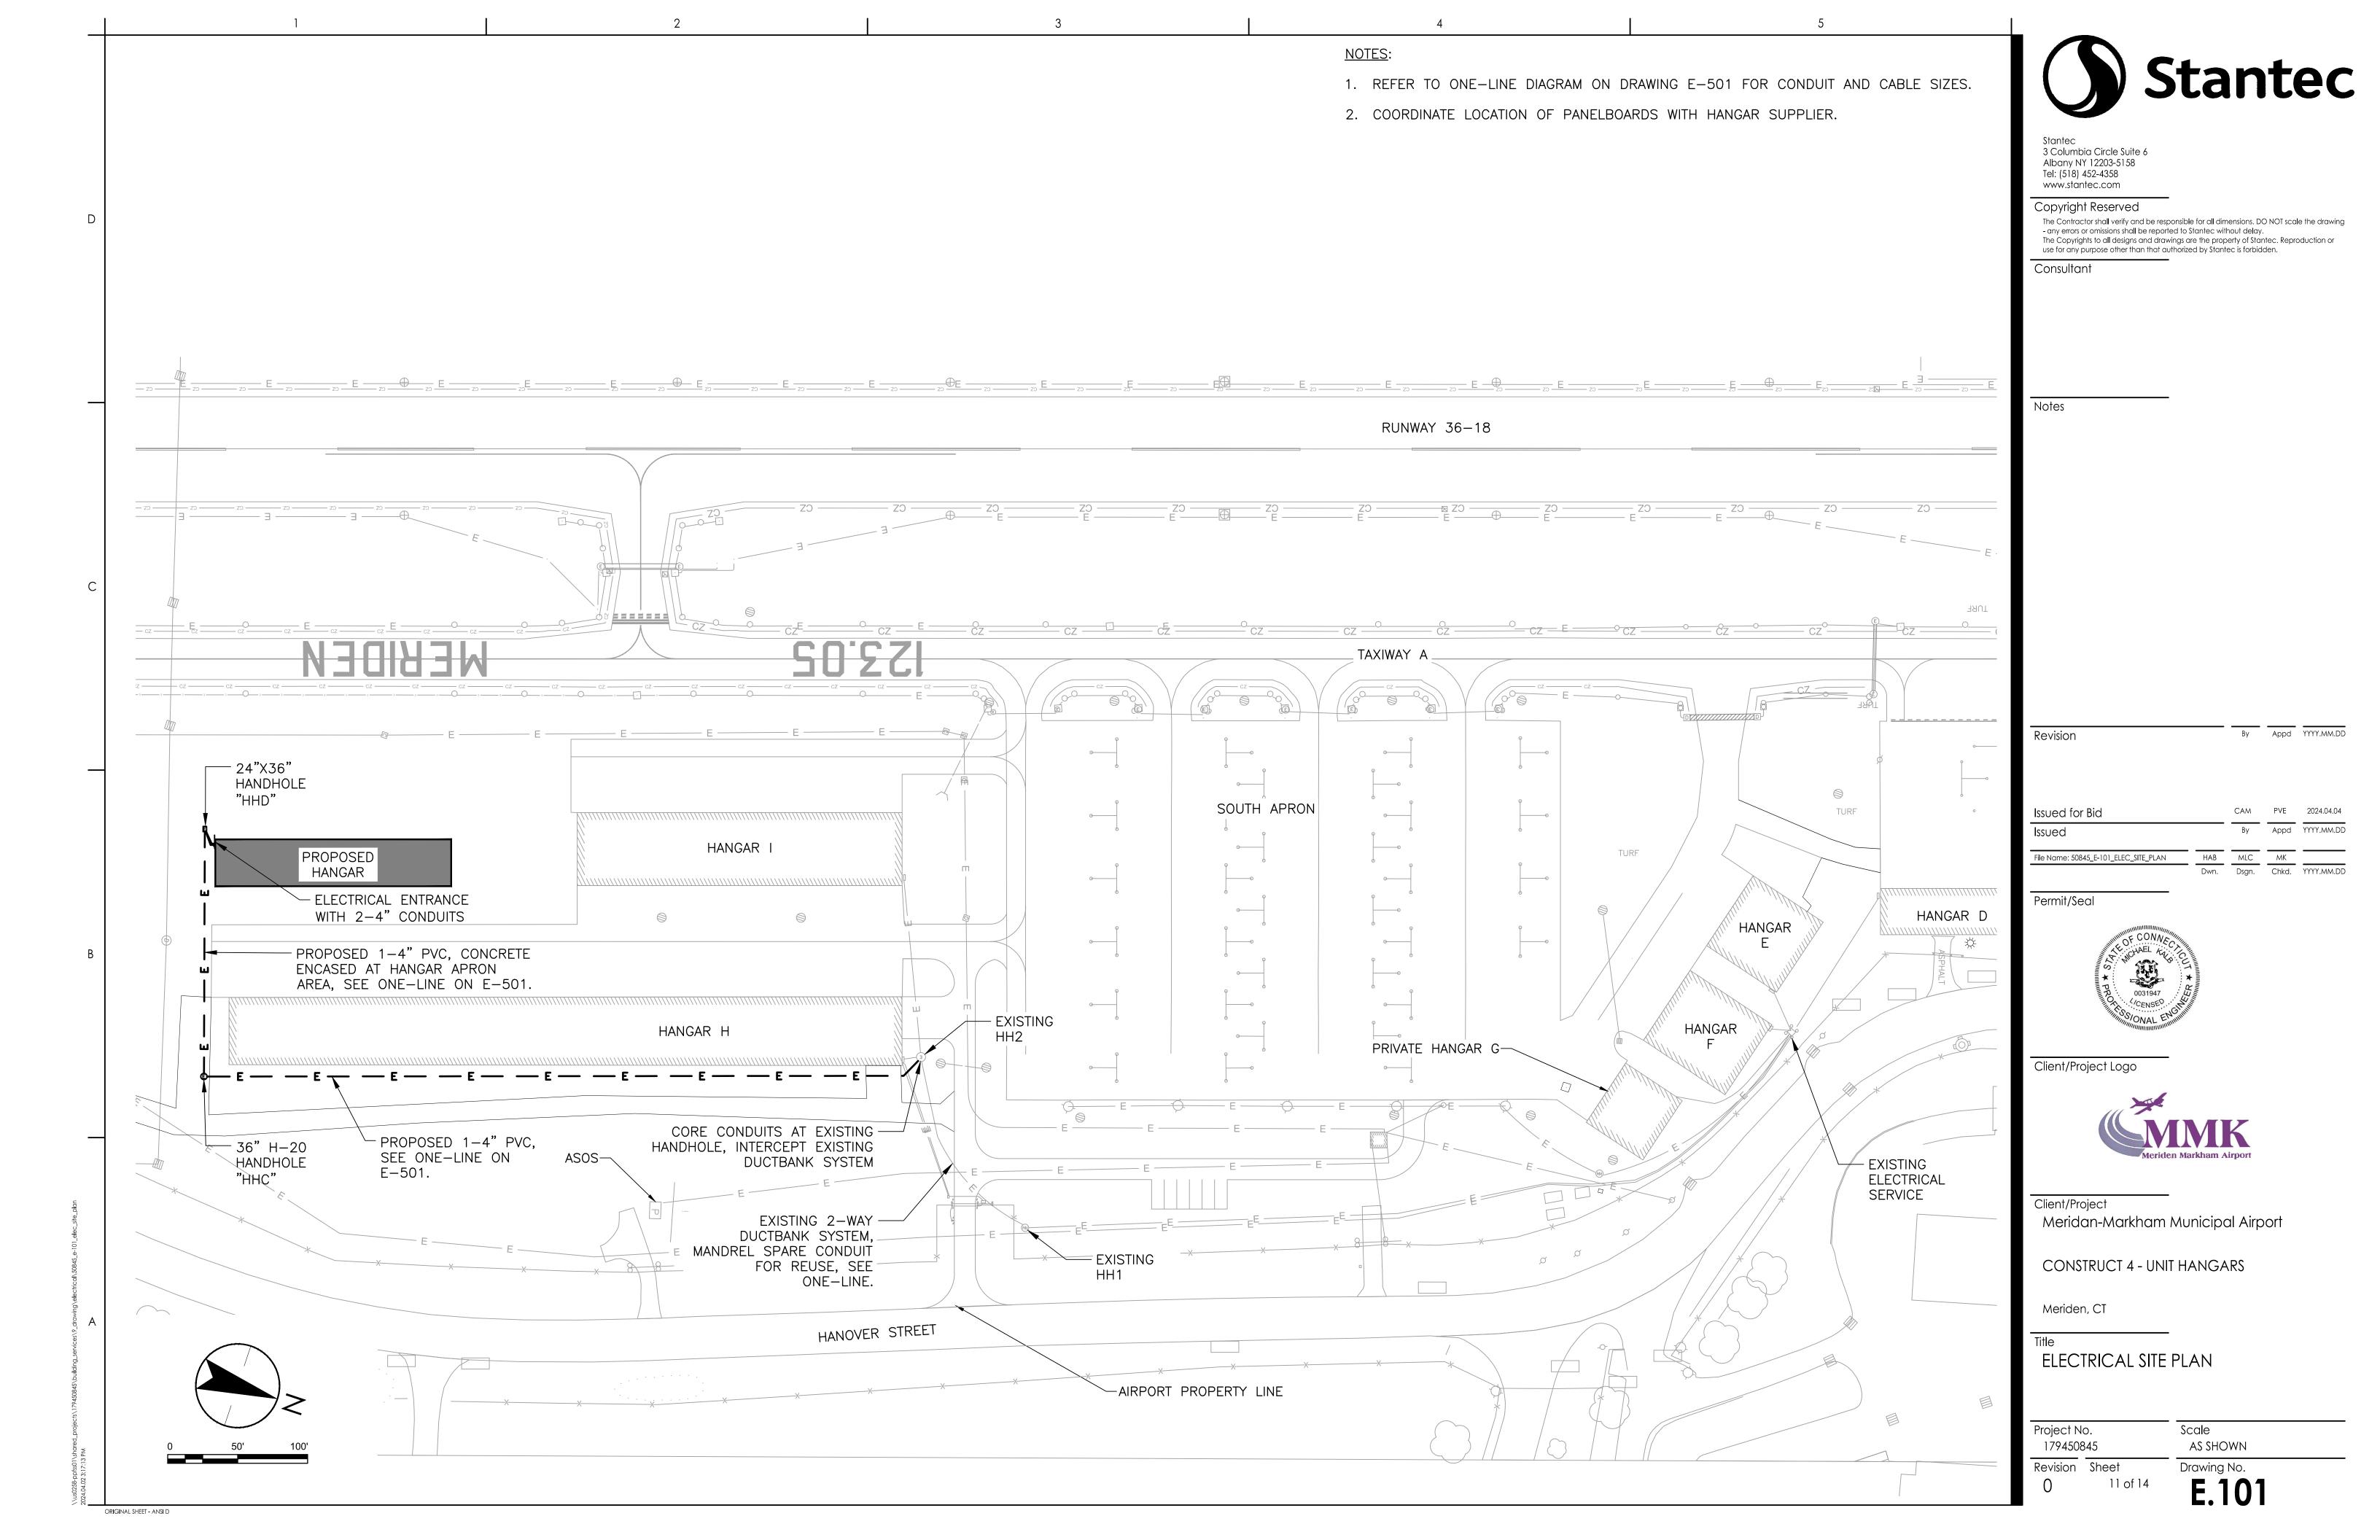

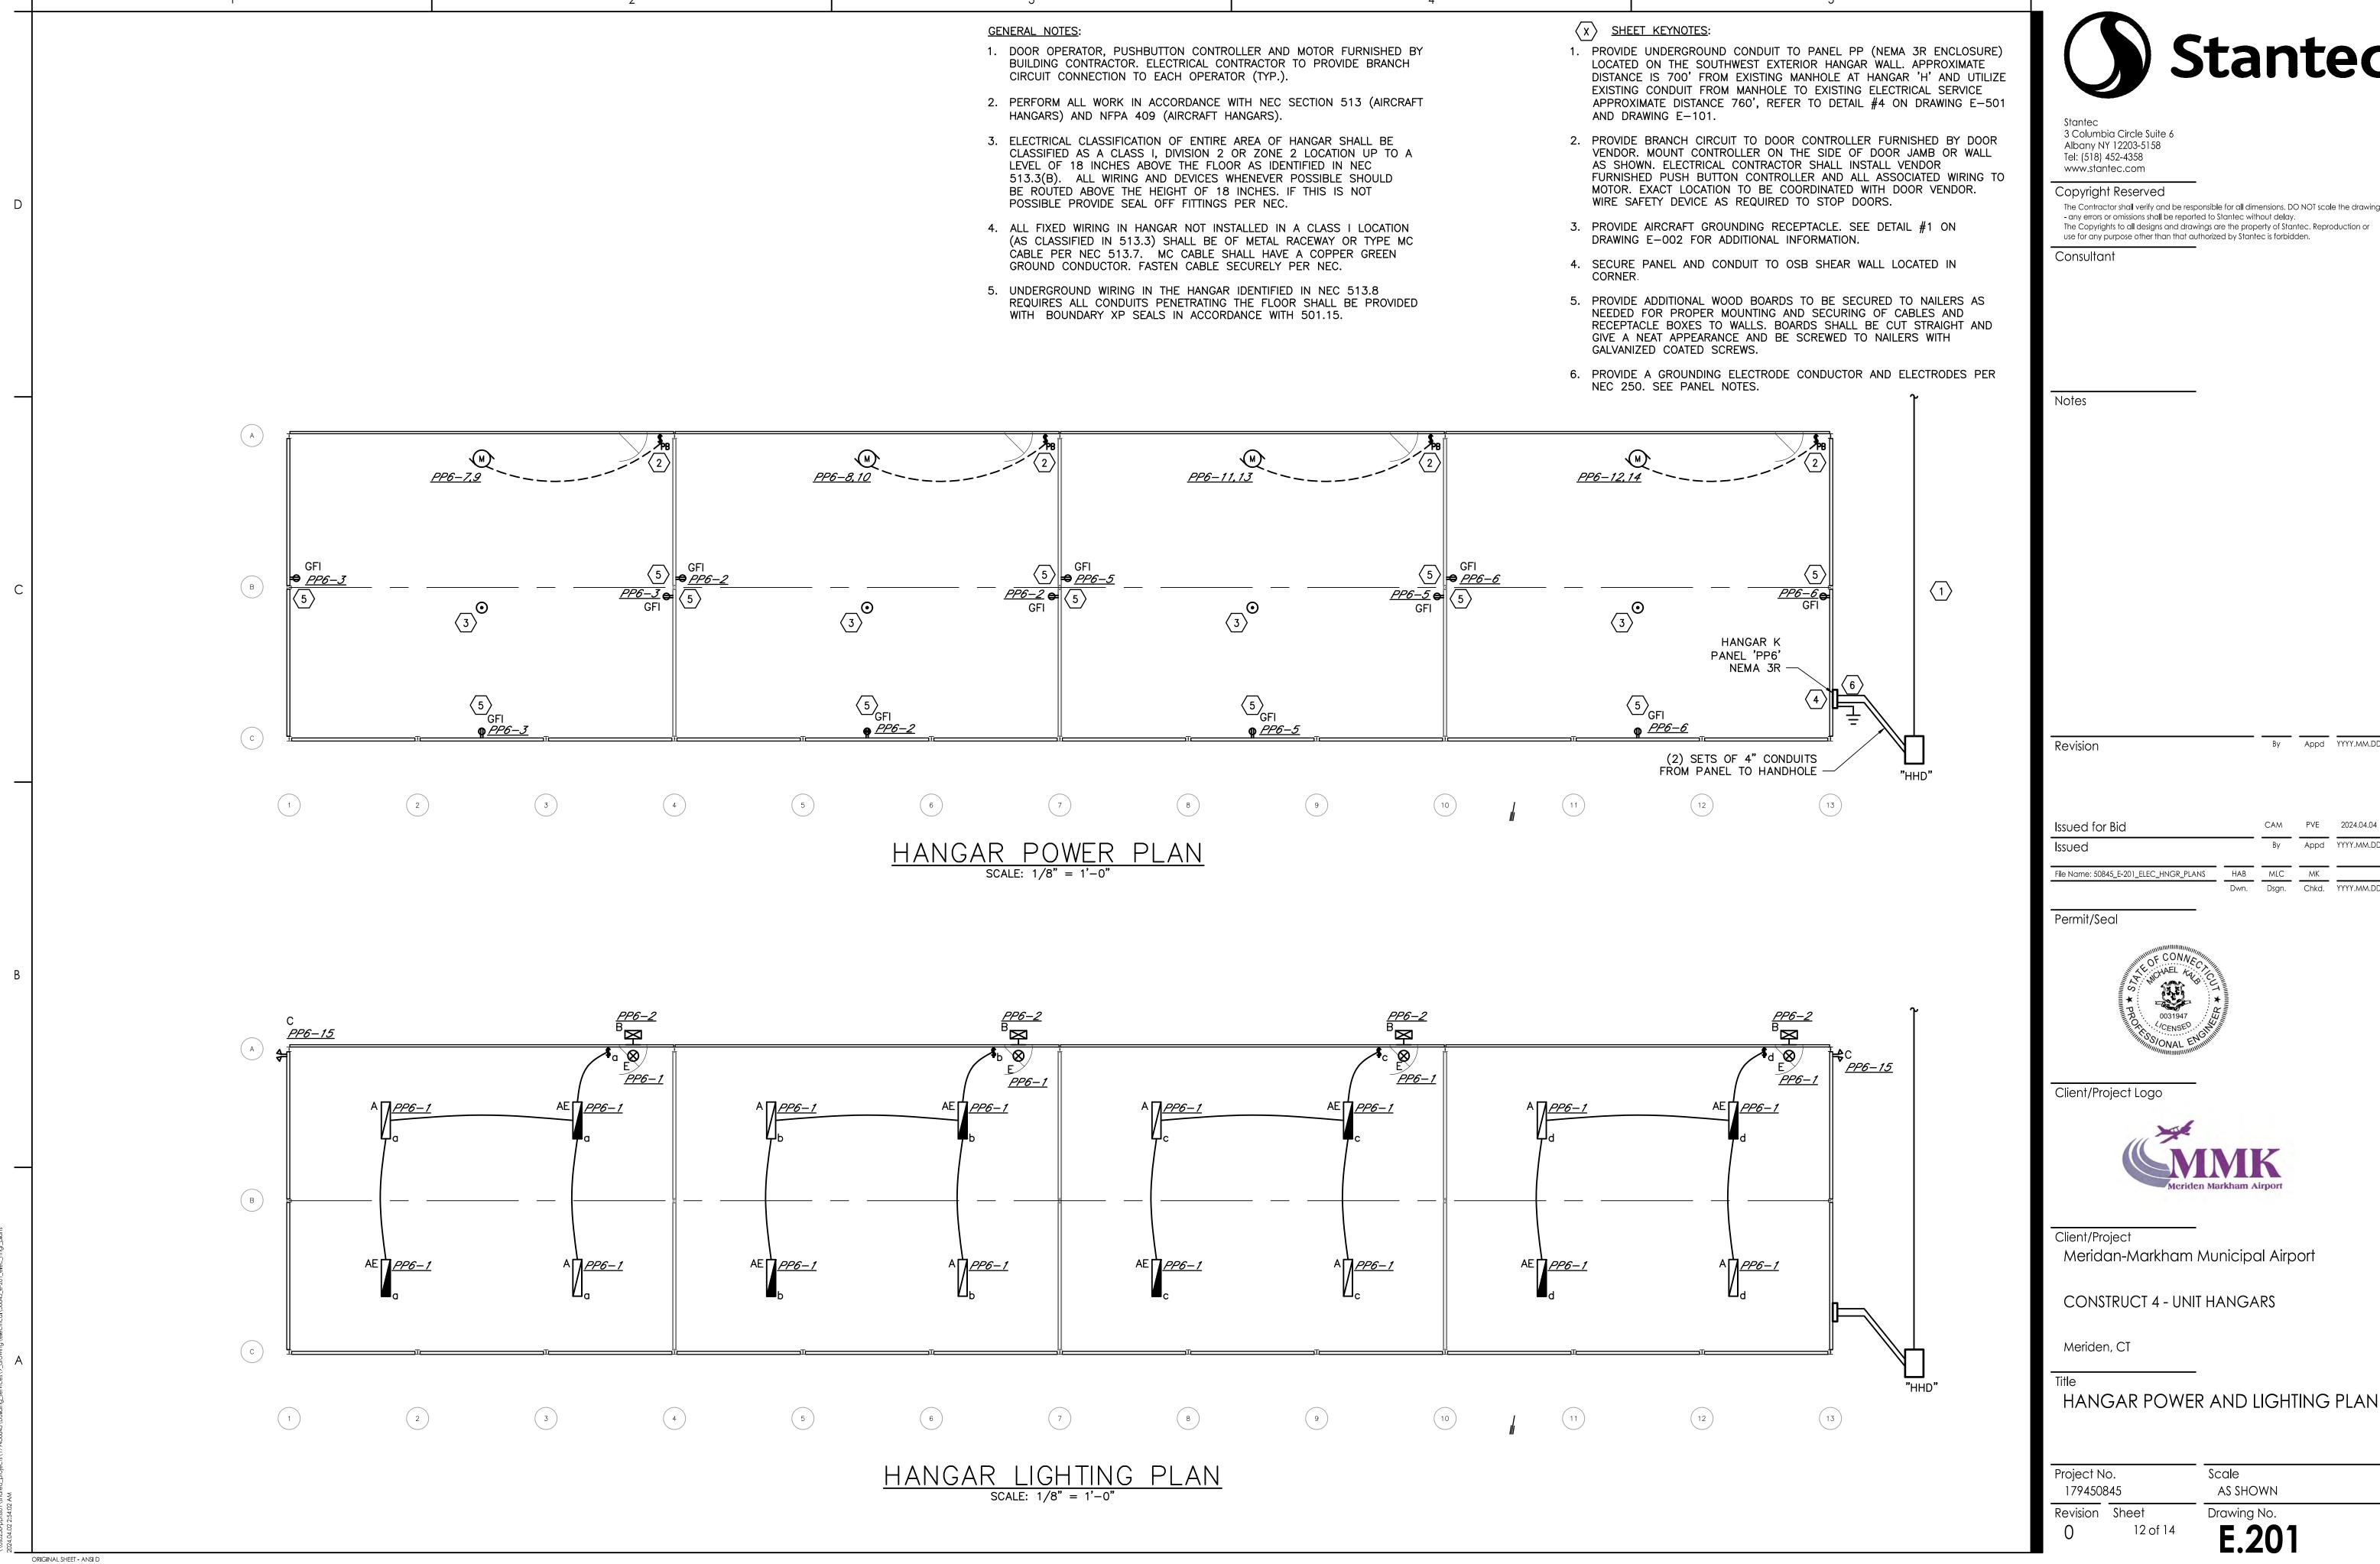



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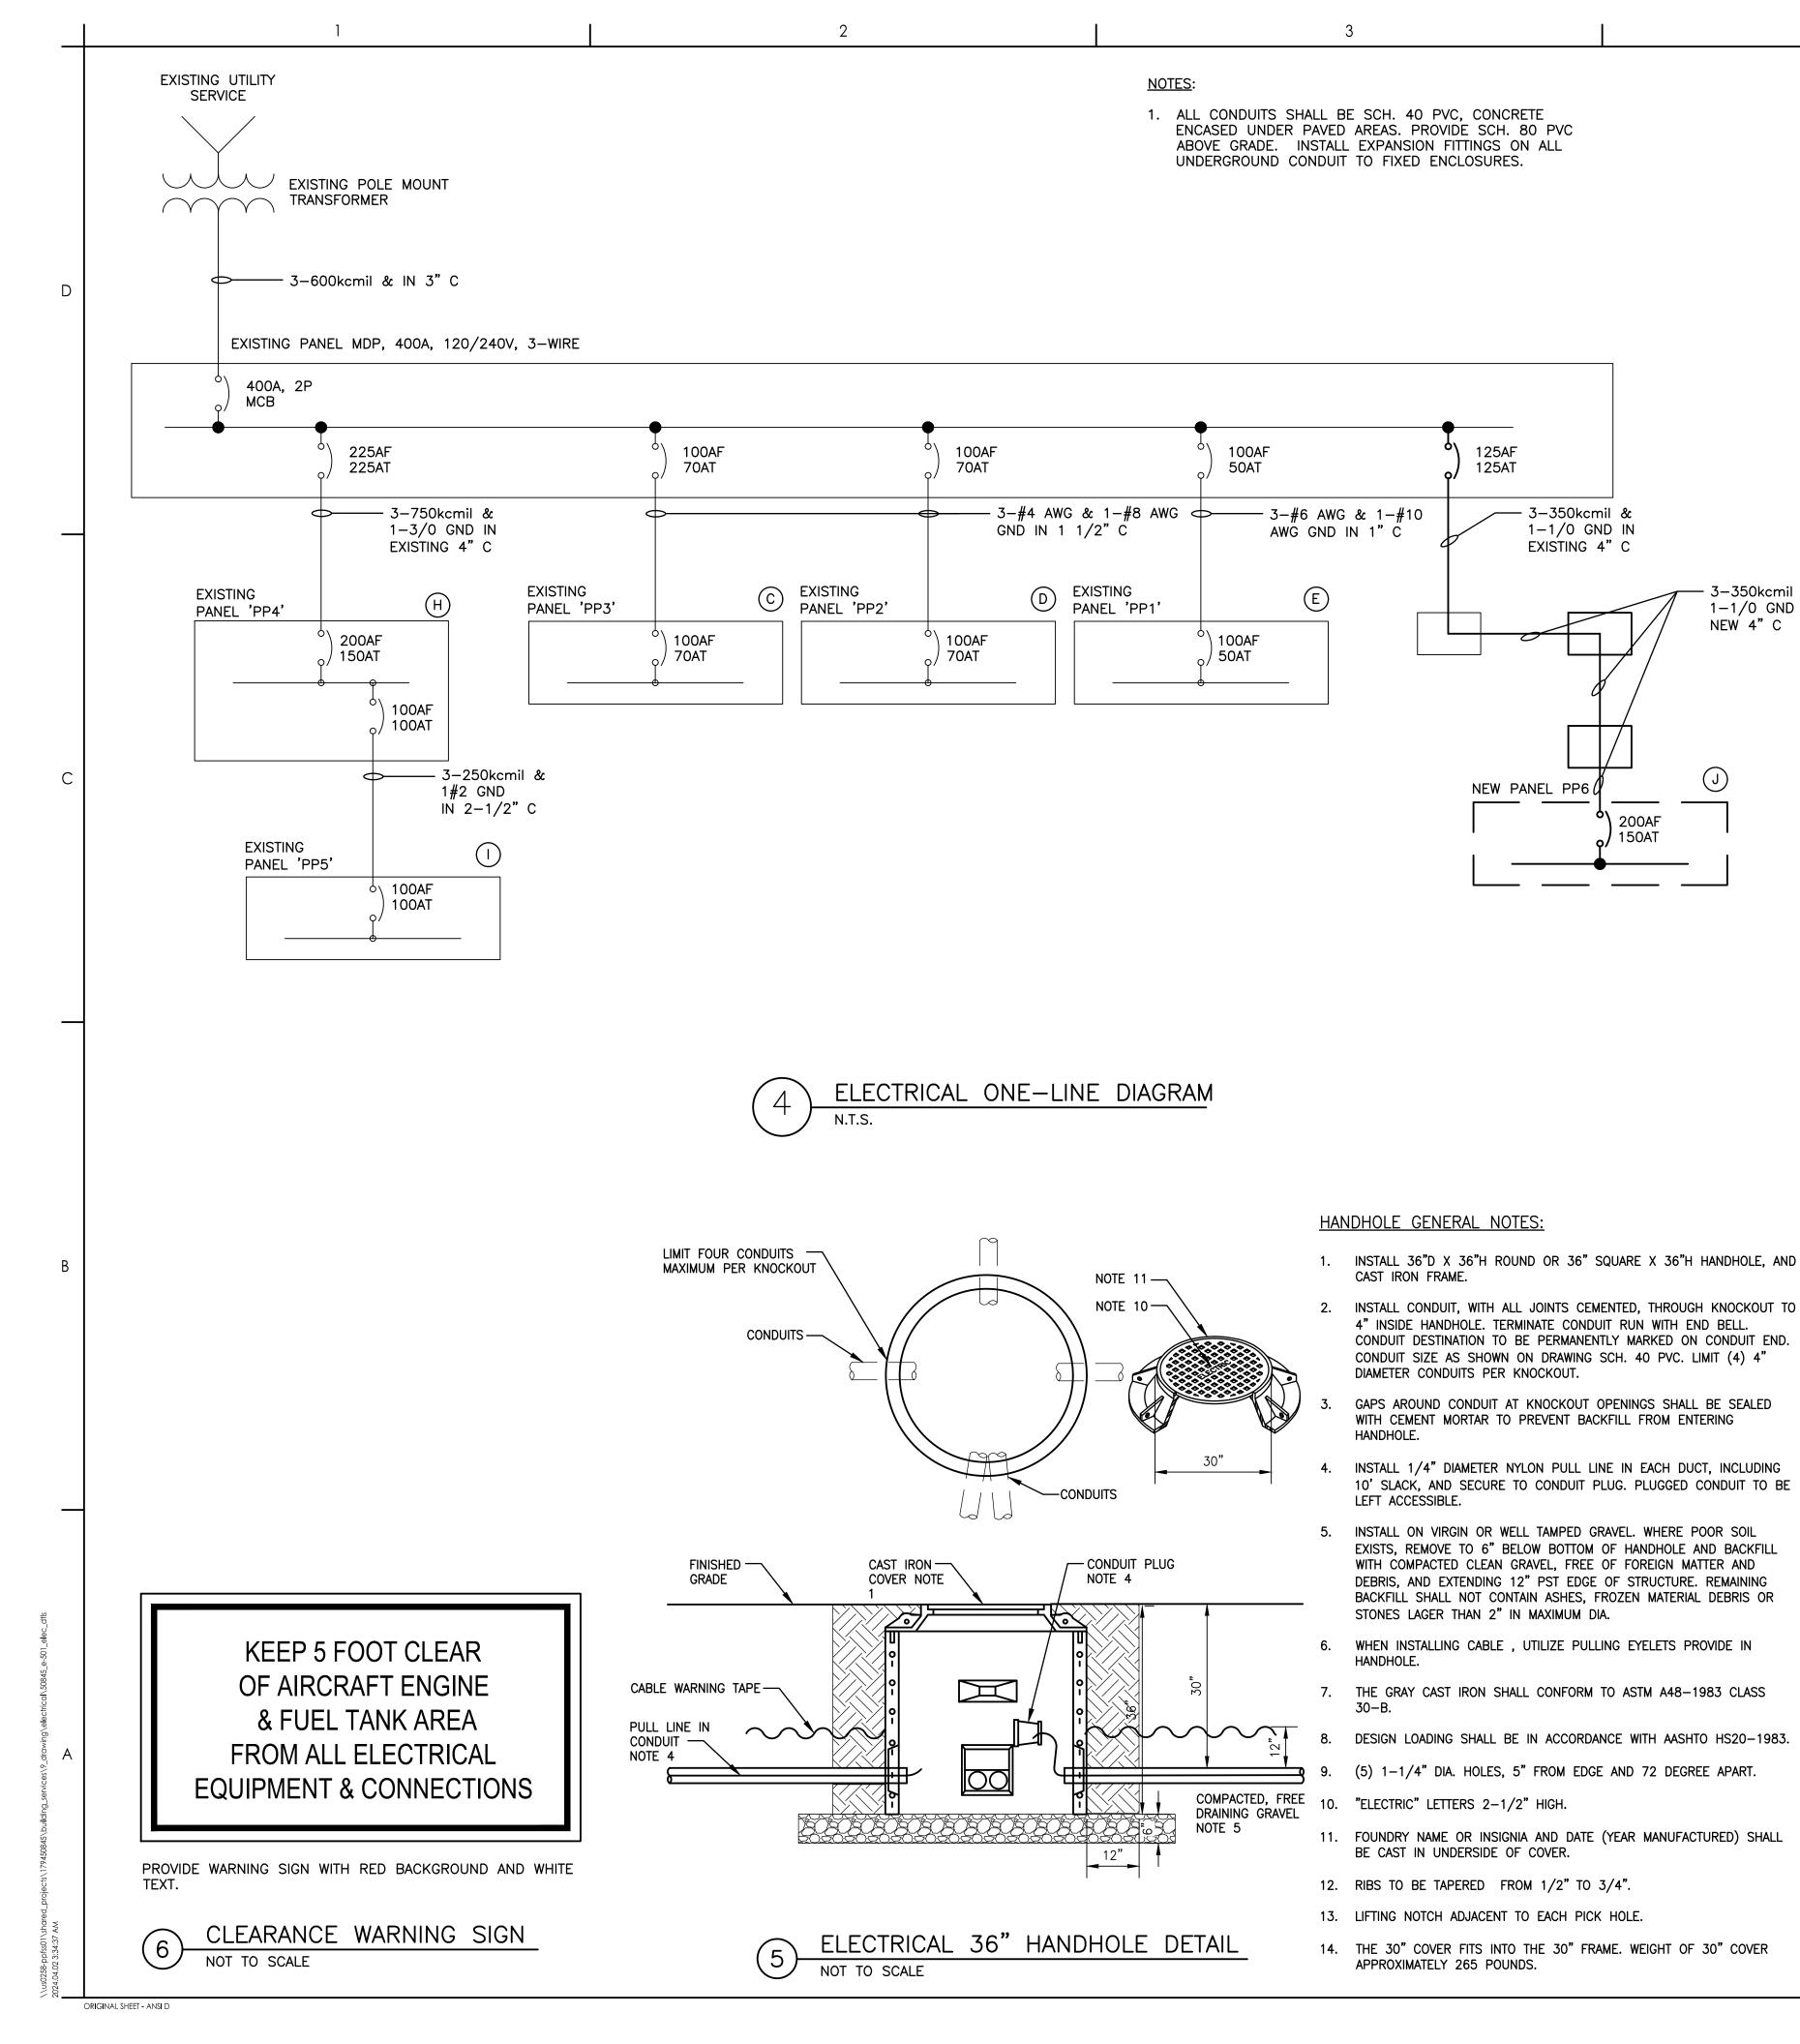
Appd YYYY.MM.DD




HANGAR POWER AND LIGHTING PLAN

AS SHOWN

**E.201** 



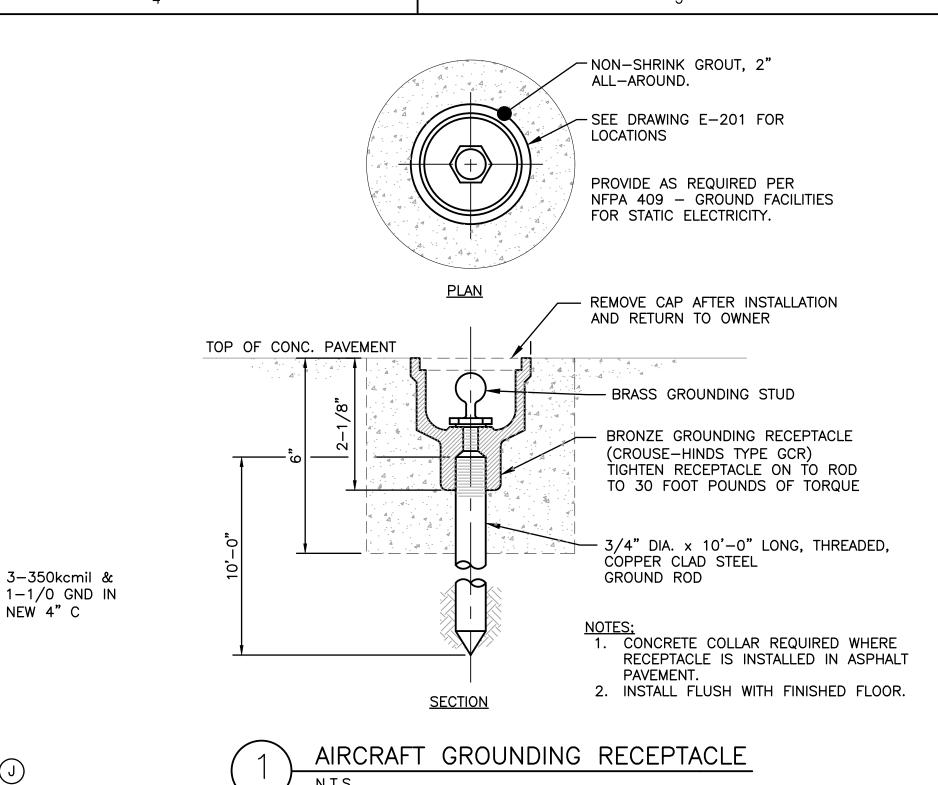


- 3-350kcmil &

1-1/0 GND IN

EXISTING 4" C


200AF 150AT · 3-350kcmil &

NEW 4" C

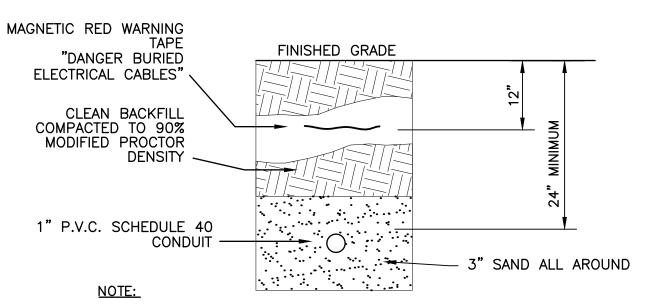

1. THERE IS APPROXIMATELY 20' OF DRIVEWAY THAT WILL REQUIRE TO BE SAWCUT AND REPLACED IN KIND.

TYPICAL UNDERGROUND CONDUUIT DETAIL

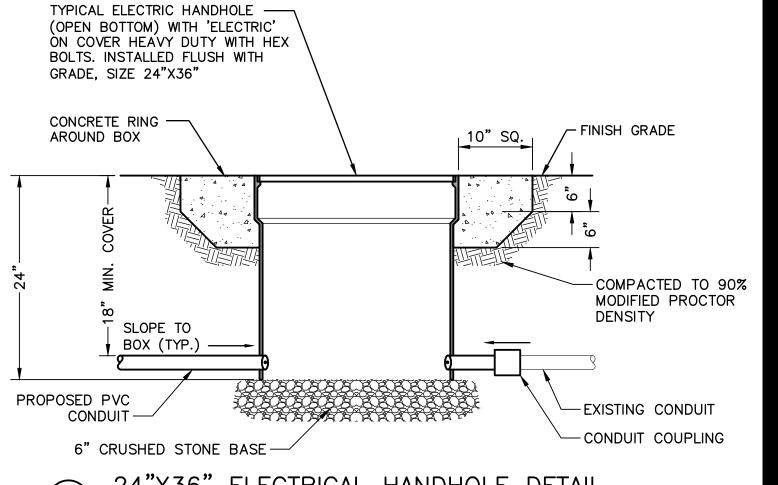

24"X36" ELECTRICAL HANDHOLE DETAIL NOT TO SCALE NOTE: PROVIDE DIMENSIONS AS REQUIRED BY NEC



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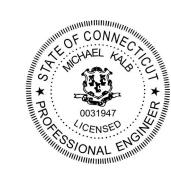
Notes

By Appd YYYY.MM.DD Revision

CAM PVE 2024.04.04 Issued for Bid Appd YYYY.MM.DD Issued

File Name: 50845\_E-501\_ELEC\_DTLS

Permit/Seal



Client/Project Logo



Client/Project Meridan-Markham Municipal Airport

CONSTRUCT 4 - UNIT HANGARS

Meriden, CT

**ELECTRICAL ONE-LINE AND DETAILS** 

Project No. 179450845 Revision Sheet 13 of 14 Scale AS SHOWN Drawing No. **E.50**1 LUMINAIRE SCHEDULE

MARK	MANUFACTURER	CATALOG NUMBER	DESCRIPTION OR SIZE	COLOR	MOUNTING		LIGHT SC	URCE			TOTAL
ID						TYPE	LUMENS	CCT(K)	L70	1	WATTS
Α	COLUMIBIA	LXEM4-35VL-DFA-EU-XEHC-WITH OCCUPANCY SENSOR OS2360WLK	4' VAPORPROOF LINEAR LED	WHITE	CHAIN MOUNT AT 14' AFF	LED	7086-8415	3500	60K HRS	120V	62
AE	COLUMIBIA	LXEM4-35VL-DFA-EU-ELL14-XEHC-WITH OCCUPANCY SENSOR OS2260WLK	4' VAPORPROOF LINEAR LED - EMERGENCY INTEGRAL COLD WEATHER BATTEY PACK		CHAIN MOUNT AT 14' AFF	LED	7086-8415	3500	60K HRS	120V	62
В	HUBBELL	LNC3-24L-3K-075-3-1-BL-PCU-EH	EXTERIOR LED ABOVE MAIN DOOR - EMERGENCY PACK AND INTEGRAL PHOTOCELL	BLACK	SURFACE	LED	4784	3000	50K HRS	120V	55
С	FLIGHT LIGHT	FL-810-R-AC1-D-HUB-P	TWIN L-810 OBSTRUCTION LIGHTS - COORDINATE WITH FAA REGULATIONS	RED & YELLOW	SURFACE	-	•	·	-	120V	232
E	HUBBELL	EVEURWEI	EXIT SIGN WITH BATTERY BACKUP AND INTEGRAL HEATER	WHITE	SURFACE	RED LED	-	-	-	120V	2

#### OTES:

- 1. ALL NECESSARY MOUNTING HARDWARE, HANGERS, BREAKET, STEMS, CHAINS, ETC SHALL BE PROVIDED.
- ALL LUMINAIRES LISTED ARE DESING BASE, ENGINEER MUST APPROVE EQUALS;
   LUMINAIRES SHALL BE SEISMICALLY SUPPORTED AS REQUIRED BY THE CONNECTICUT STATE BUILDING CODE.
- 4. ALL EXIT SIGNS SHALL BE WIRED TO THE LINE SIDE OF THE SIDE OF LOCAL LIGHTING CIRCUIT, AHDEAD OF ALL SWITCH DEVICES.

BUS	125 <i>A</i>	4			Р	AN	EL I	No	. P	Pe	6					LOCATION O	UTDOOR			
PANEL RATING	10 k	AIC												•		MOUNTING SI	URFACE			
SUPPLY VOLTA	AGE 120/24	IOV														DRAWING No.				
SERVICE	1 PHA	SE, 3 WIRE																		
WIRING	3	DESCRIPTION	0005	VA C	DR W	BRE.	AKER	CKT.	. BUS CKT		BREAKER		VA C	OR W		DESCRIPTION		WIRING		
WIRE	COND	1	CODE	ØΑ	ØB	POLE					POLE		ØΑ	ØB	CODE			COND	WIRE	
2#8, #8G	3/4"	INTERIOR LIGHTING	LTS	1000		1	20	1	-	2	1	20	240		LTS	LTS - OUTSIDE		3/4"	2#8, #8G	
2#10, 1#10G	3/4"	RECP - HANGAR a	RECP		540	1	20	3	x	4	1	20		540	RECP	RECP - HANGAF	₹ b	3/4"	2#10, #10G	
2#10, #10G	3/4"	RECP - HANGAR c	RECP	540		1	20	5	x	6	1	20	540		RECP	RECP - HANGAF	R d	3/4"	2#10, #10G	
2#10, 1#10G	/ \\ 3/4" /	\\ HANGAR 1 DOOR MOTOR	/ 0		830	\\ 2 /	\\ 20 /	7	x	8	\\ 2 /	\\ 20 /		830	0	\\ HANGAR 2 DOO	R MOTOR	/ \\ 3/4" /	\\ 2#10, 1#100	
	\\ / \	/ a	// O	830		/ \\	/ \\	9	x	10	/ \'	/ \\	830		0	/ b		\\ / \\	1	
2#12, 1#12G	/ \\ 3/4" /	\\ HANGAR 3 DOOR MOTOR	/ 0		830	\\ 2 /	\\ 20 /	11	x	12	\\ 2 /	\\ 20 /		830	0	\\ HANGAR 4 DOO	R MOTOR	/ \\ 3/4" /	\\ 2#12, 1#120	
\\\ / \\\ / c		7/ O	830		/ \\	/ \\	13	x	14	/ \\	/ \\	830		0	/ d		\\ / \\	1		
		LTS - BEACONS - WEST SIDE	LTS		460	1	20	15	x	16	1	20				SPARE				
		SPARE				1	20	17	x	18	1	20				SPARE				
	_	SPARE				1	20	19	x	20	1	20				SPARE				
2#10, 1#10G	/ \\ 3/4" /	\\ SPD	/ POWR			\\ 2 /		21				\\ 60 /				\\ FUTURE		/ \\ /		
	\\  / \	\ /	N POWR			/ \\	/ \\	23		24		/ \\				/		\\	1	
		TOTAL 1		3200	2660				Ľ	TOTA	L 2		2440	2200						
		TOTAL 2		2440	2200															
		TOTAL 1 + 2		5640	4860	]														
		CONN. LOAD TOTAL	,		10500	_	MAIN BREAKER 125								MAIN LUGS			MCB		
CONN. AMPERES TOTAL			,	_	FEEDER ENTRANCE TOP/BOTTOM									ENCLOSURE TYPE		NEMA 3R				
		EST. DEMAND LOAD TOTAL			8840															
		EST. DEMAND AMPERES TOTAL	,		37	_	SOU	_				EE ON					INDICATES LOC		E	
							PAN	EL TY	PE_			OOR-IN	-DOOR			**	* TWISTLOCK RE	ECPTACLE		

ANEL RATING JPPLY VOLTAG ERVICE					-	AN					ng Pai	nel					MOUNTING SURFACE DRAWING No.				
WIRING		DESCRIPTION	CODE		/A OR V							REAKEF			'A OR V	CODE	DESCRIPTION			WIRING	
WIRE	COND			ØΑ		POLE						E A		ØA	ØВ				COND	WIRE	
		\\ HANGARS /	POWR	3362		\\ 2 /	/\\ 60				₩ 2	/ \\ 70	/ 5	640			\\ HANGAR E	/ \\			
-	1	/ PRIVATE \\	POWR		990	/ \\	\ /	11 3			/	\\ /	//		4860		/ 4 UNITS	11/1	\\ /		
		\\ HANGAR C /	POWR	2902		\\ 2 /	/\\ 70					/ \\ 70	/ 3	375			\\ LTS - SITE LIGHTING	/ \\			
	\	· · · · · · · · · · · · · · · · · · ·	PÓWR		990	/ \\	\	11 7				\\ /	11		375	LTS	/ 3 north	W /	11/		
EXISTING /	/ \\	\\ LTS - SITE LIGHTING /	LTS	375		\\ 2 /	/\\ 20					/ \\ 20	/ 4	400		LTS	\\ LTS - SITE LIGHTING	/ \\	/[\	\ EXISTING	
<u> </u>	1	/ 3 north \\	LTS		375	/ \\	\ /	\\ 11			_	W/	//		400	LT\$	/ 2 south	W/	11/		
		\\ LTS - SITE LIGHTING /	LTS	600		\\ 2 /	/ \\ 20					/\\ 70	/ 3	114			\\ HANGAR D	/ \\			
	\ \ \ \ \\	/ 3 south \\	LTS		600	/ //	\ /	15				W /	//		990	POWR	/	W/	N/		
	3/4"	RECP - AT PANEL	RECP	180		1	20	17		18		20		190		LTS	LTS - CONTROL TIME CLOCK				
		SPARE				1	20	19	1 1			/ \\ 70	1			POWR	\\ SPARE - Private Hangar if Room	/ N			
		SPARE				1	20	21		22		1517	11			POWR	<i> </i>	1 //	\\	1	
		SPARE				1	20	23		24	1	20					SPARE				
		SPARE				1	20	25	х	26							SPACE				
		SPACE						27	x	28							SPACE				
		SPACE						29	х	30							SPACE				
		SPACE						31	x	32	11 2	/\\125	7		4860	POWR	// HANGAR J	1 11	1	\ SEE RISER	
		SPACE						33		34		W/	۱۱ 5	640		POWR	1	11/1	11 /	l .	
		SPACE						35	x		\\ 2	7 \\	7			POWR	//	/ \\	/[\	I	
		SPACE						37	11	38		\\ /	11			POWR	/	W /	11		
		SPACE						39				/\\225			16140		\\ HANGAR H & I	7   \			
		SPACE						41		42				3140	]	POWR	<i> </i> /	\\[\	W/		
		TOTAL 1		7419	2955	]				TOT	AL 2		3′	1499	27625						
		TOTAL 2			27625	]															
		TOTAL 1 + 2		38918																	
	'	CONN. LOAD TOTAL			69498	-	MAIN BREAKER 400 100% RATED							ED			MAIN LUGS		MCB		
		CONN. AMPERES TOTAL	•	290	FEEDER ENTRANCE TOP/BOTTOM							M			ENCLOSURE TYPE NEMA 3R ACCESSORIES * INDICATES GFI BREAKER						
		EST. DEMAND LOAD TOTAL	86866 362			-	FEEDER SIZE 400 A SEE ONE-LINE							INE							
		EST. DEMAND AMPERES TOTAL				-	SOURCE SEE ONE-LINE										** INDICATES LOCK ON DEVICE				
							PANEL TYPE DOOR-IN-DOOR										*** TWISTLOCK RECPTACLE				
LD INDICATES	NEW LO	ADS							_												



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Notes

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 PVE
 2024.04.04

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 By
 Appd
 YYYY.MM.DD

File Name: 50845\_E-501\_ELEC\_DTLS

Permit/Seal



Client/Project Logo



Client/Project

Meridan-Markham Municipal Airport

CONSTRUCT 4 - UNIT HANGARS

Meriden, CT

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ELECTRICAL SCHEDULES

179450845

Revision Sheet

14 of 14

Project No.

Scale AS SHOWN

Drawing No.
E.601

ORIGINAL SHEET - ANSI D